Hickman County Health Department

INTERIOR RENOVATION

HICKMAN COUNTY

Centerville, Tennessee

										Dro	awing S	Sheet List									
	TLM Associates, Inc. GENERAL / CIVIL SHT# REV REV DATE SHEET TITLE		TLM Associates, Inc. ARCHITECTURAL						TLM Associates, Inc. JM2			2 Associates		JM2	2 Associates	JM2 Associates					
								STRUCTURAL			MECHANICAL		PLU	PLUMBING / FIRE PROTECTION		ELECTRICAL					
SHT# REV R			SHT# REV REV DATE		SHEET TITLE	SHT# REV REV DATE SH		SHEET TITLE	SHT#	REV REV I	REV REV DATE SHEET TITLE		SHT# REV REV DATE		SHEET TITLE	SHT# REV	REV DATE	SHEET TITLE	SHT#	REV REV DATE SHEET	T TITLE
CS.1	COVE	ER SHEET	A1.0		FLOOR PLAN - DEMO				STRUC	TURAL	NOTI	N SCOPE OF THIS PR	OJECT M1.1		HVAC PLAN	P1.1		PLUMBING PLAN	E0.0	SCHEDULES, NO	TES AND
			A1.1		FLOOR PLAN- PROPOSED															DETAILS	
																			E0.1	ELECTRICAL DEA	MOLITION PLAN
			A2.1		FINISH FLOOR PLAN																
																			E2.1	LIGHTING PLAN	
			A3.1		DOORS AND WINDOWS														E2.1A	ALTERNATE LIGH	HTING PLAN
			A7.1		MILLWORK ELEVATIONS														E3.1	POWER PLAN	
			A7.2		MILLWORK SECTIONS																

Site Address

APPLICABLE CODES/REGULATIONS:

2018 International Building Code 2012 International Energy Conservation Code 2018 International Fuel Gas Code 2018 International Mechanical Code 2018 International Plumbing Code National Electric Code, 2017 Edition 2018 International Fire Code 2012 NFPA 101 Life Safety Plan ICC/ ANSI A117.1 Accessible & Usable Buildings &

2010 ADA Standards for Accessible Design

Facilities, 2009 Edition

 Type II-B, Non-Sprinklered OCCUPANCY GROUP (IBC CH 3):

TYPE OF CONSTRUCTION (IBC CH 6):

Single-Occupancy, One Story Building - IBC 508.3 -

Nonseparated Business Group (B)

NUMBER OF STORIES (IBC TABLE 504.4):

Allowed: 3 stories Proposed: 1 stories

BUILDING HEIGHT (IBC TABLE 504.3): Allowed: 75'-0" Proposed: 33'-0"

OCCUPANT LOAD (IBC CH 10): TOTAL OCCUPANT LOAD: 48 PERSONS

TOTAL BUILDING AREA (NET) = 4,825 SF

FIRE AREA DIVISION:

IBC 508.3.3 - No separation is required between nonseparated occupancies.

MEANS OF EGRESS:

IBC SECTION 1005.3.2 - EGRESS COMPONENT CAPACITY STAIRWAYS- 0.3" PER OCCUPANT, MINIMUM WIDTH

CODE ANALYSIS SUMMARY

44'' OTHER EGRESS COMPONENTS - 0.2" PER OCCUPANT, MINIMUM WIDTH 44", MINIMUM DOOR CLEARANCE

IBC SECTION 1010.1.2.1- EGRESS DOORS SHALL SWING IN THE DIRECTION OF EGRESS TRAVEL WHERE SERVING AN OCCUPANT LOAD OF 50 OR MORE PEOPLE.

REQ'D # OF EXITS (IBC SECTION 1006):

Proposed: 3 Exits Required: 2 Exits

CORRIDORS:

IBC 1020.1 - CORRIDORS SHALL BE FIRE-RESISTANCE RATED IN ACCORDANCE WITH TABLE 1020.1. A-3 OCCUPANCY WITH SPRINKER SYSTEM = 0 RATED REQUIRED.

IBC TABLE 1018.2 - CORRIDOR WIDTH - MINIMUM OF 44"

EXIT OR EXIT ACCESS FROM SPACES:

IBC SECTION 1006.2.1 - TWO EXITS OR EXIT ACCESS DOORWAYS FROM ANY SPACE SHALL BE PROVIDED WHERE ONE OF THE FOLLOWING CONDITIONS EXIST: 1) THE OCCUPANT LOAD EXCEEDS THE SPACES IN TABLE 1006.2.1 (A-3 = 49 OCCUPANTS; 2) THE COMMON PATH OF EGRESS TRAVEL EXCEEDS THE LIMITATIONS OF TABLE 1006.2. 1 (75 FT) OR 3) WHERE REQUIRED IN SECTION 1006.2.2.


TRAVEL DISTANCE:


IBC TABLE 1017.2 - EXIT ACCESS TRAVEL DISTANCE: SHALL NOT EXCEED 250 FT IN AN A OCCUPANCY WITH SPRINKLER SYSTEM.

IBC SECTION 1607.8.2 - GRAB BARS, SHOWER SEATS AND DRESSING ROOM BENCH SEATS SHALL BE DESIGNED TO RESIST A SINGLE CONCENTRATED LOAD OF 250 POUNDS APPLIED IN ANY DIRECTION AT ANY POINT ON THE GRAB BAR OR SEAT SO AS TO PRODUCE THE MAXIMUM LOAD EFFECTS.

LIVE LOADS:

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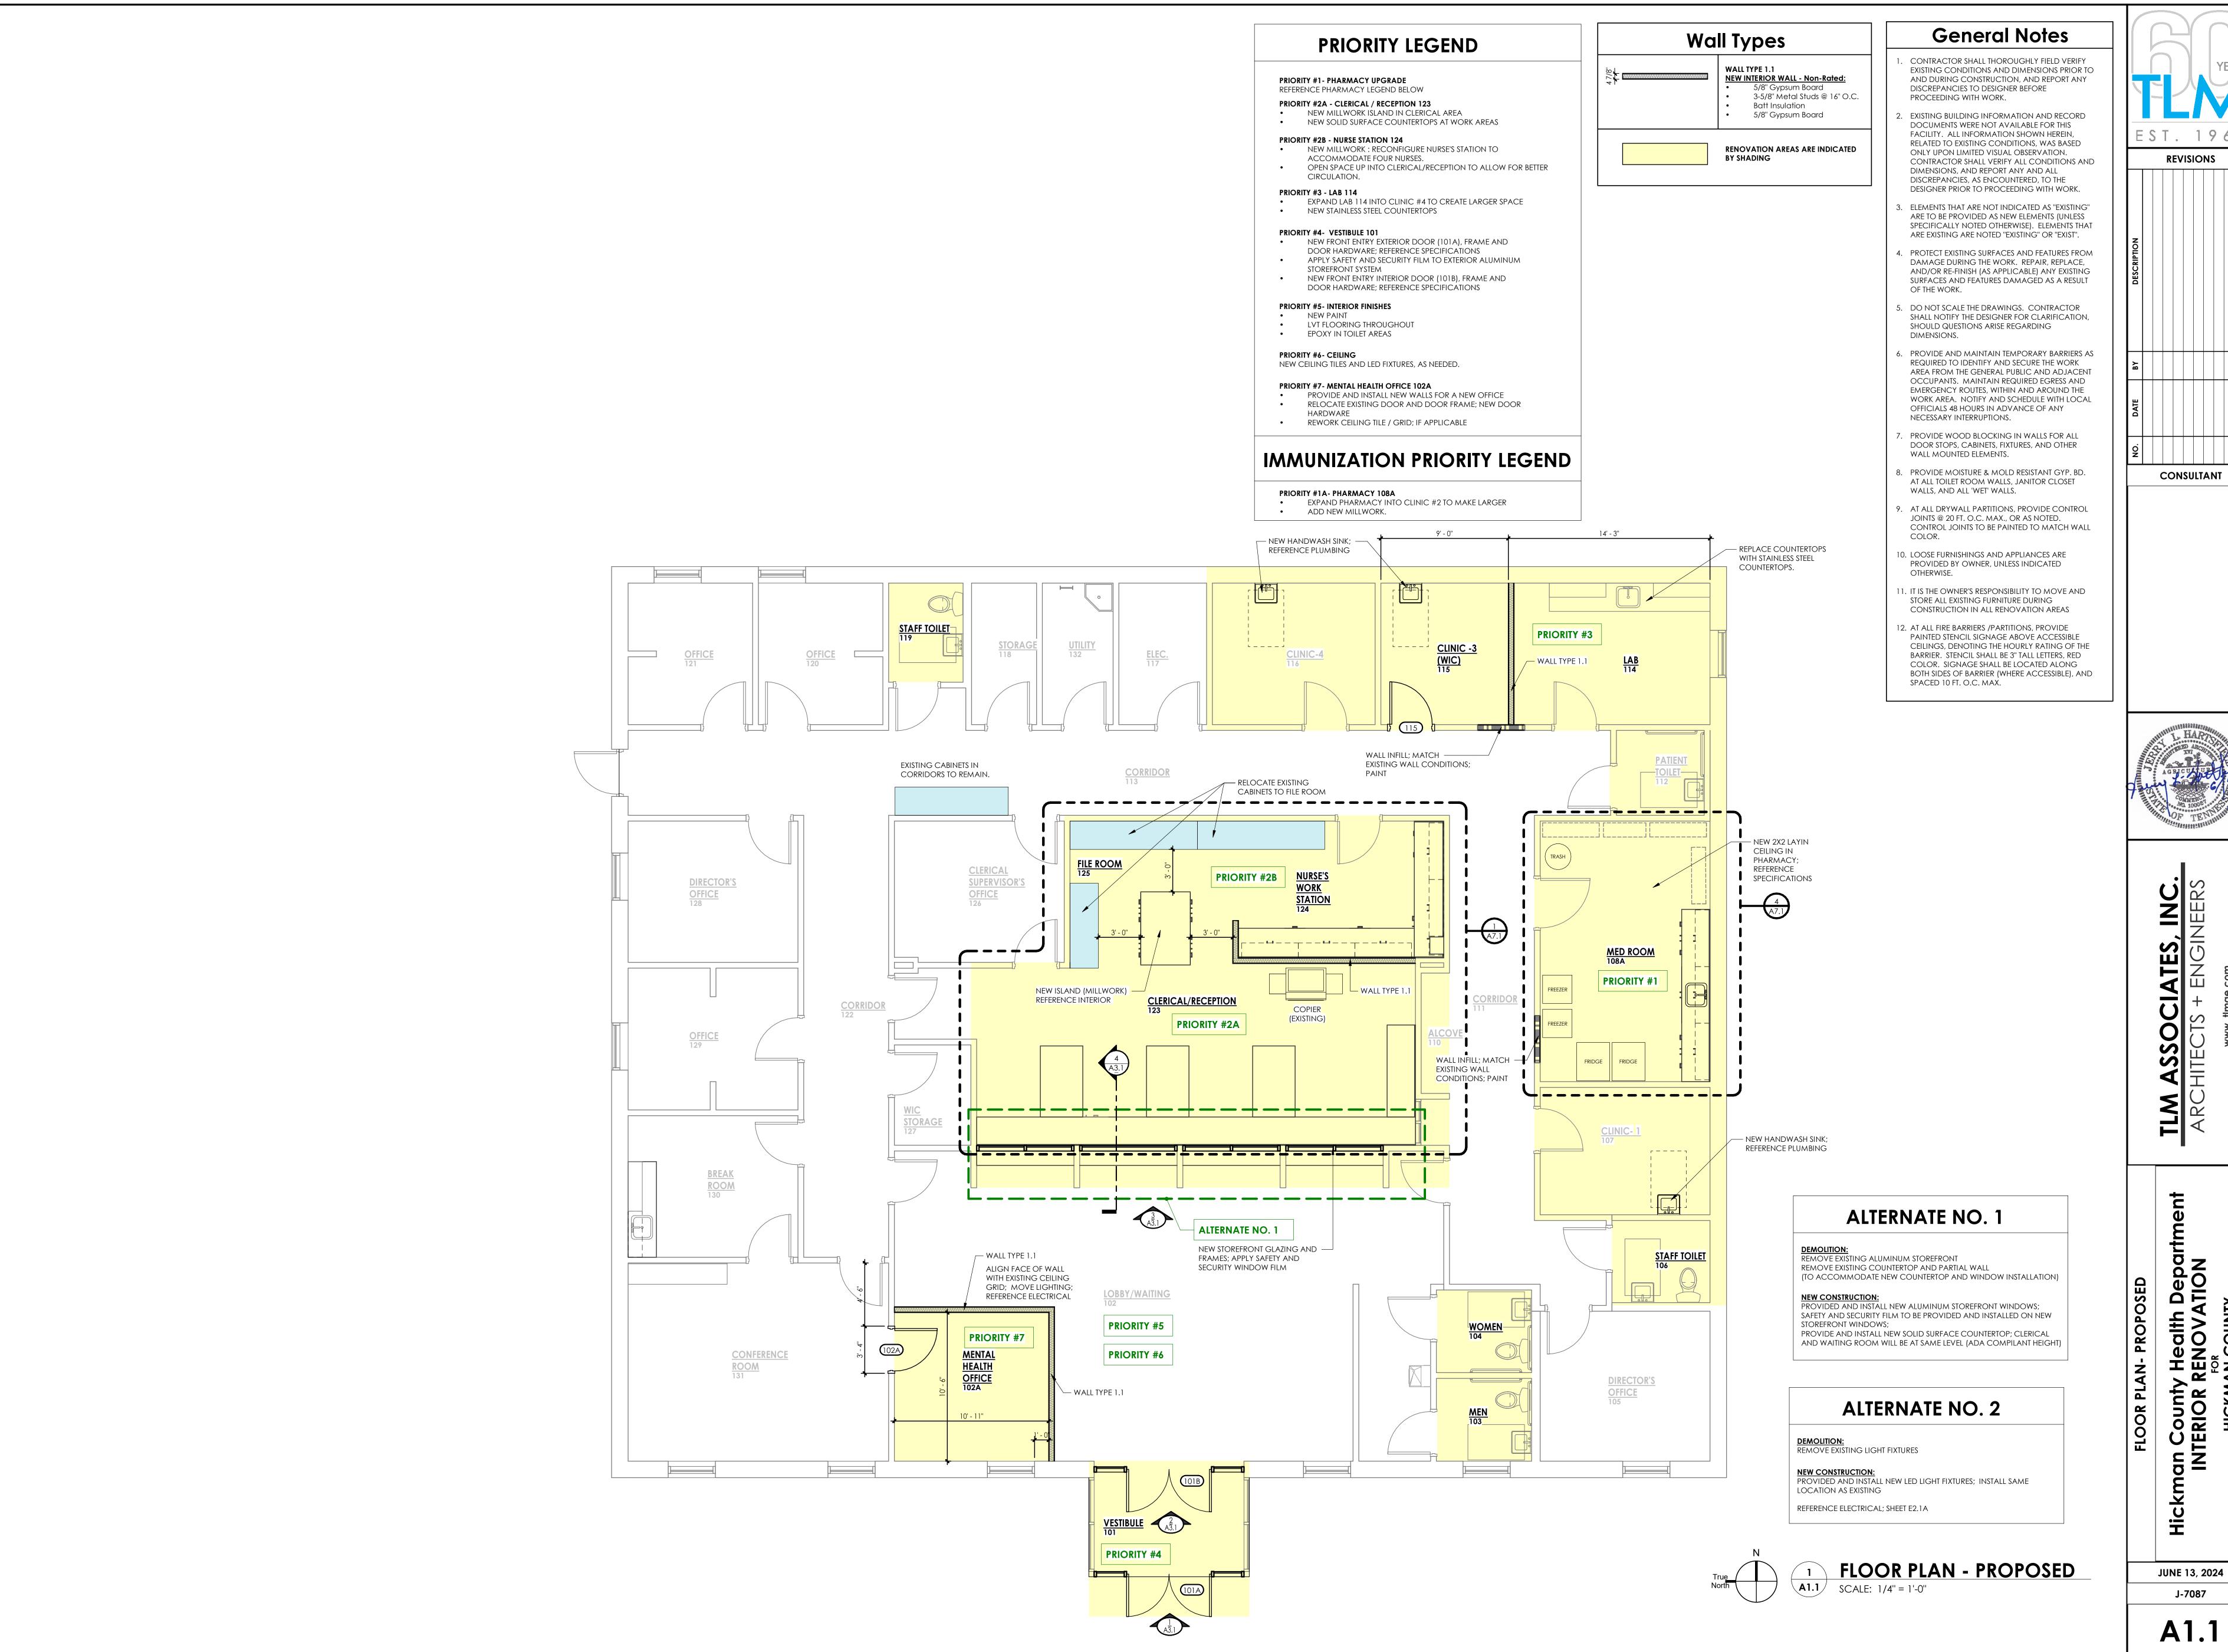
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FOR
HICKMAN COUNTY
Centerville, Tennessee

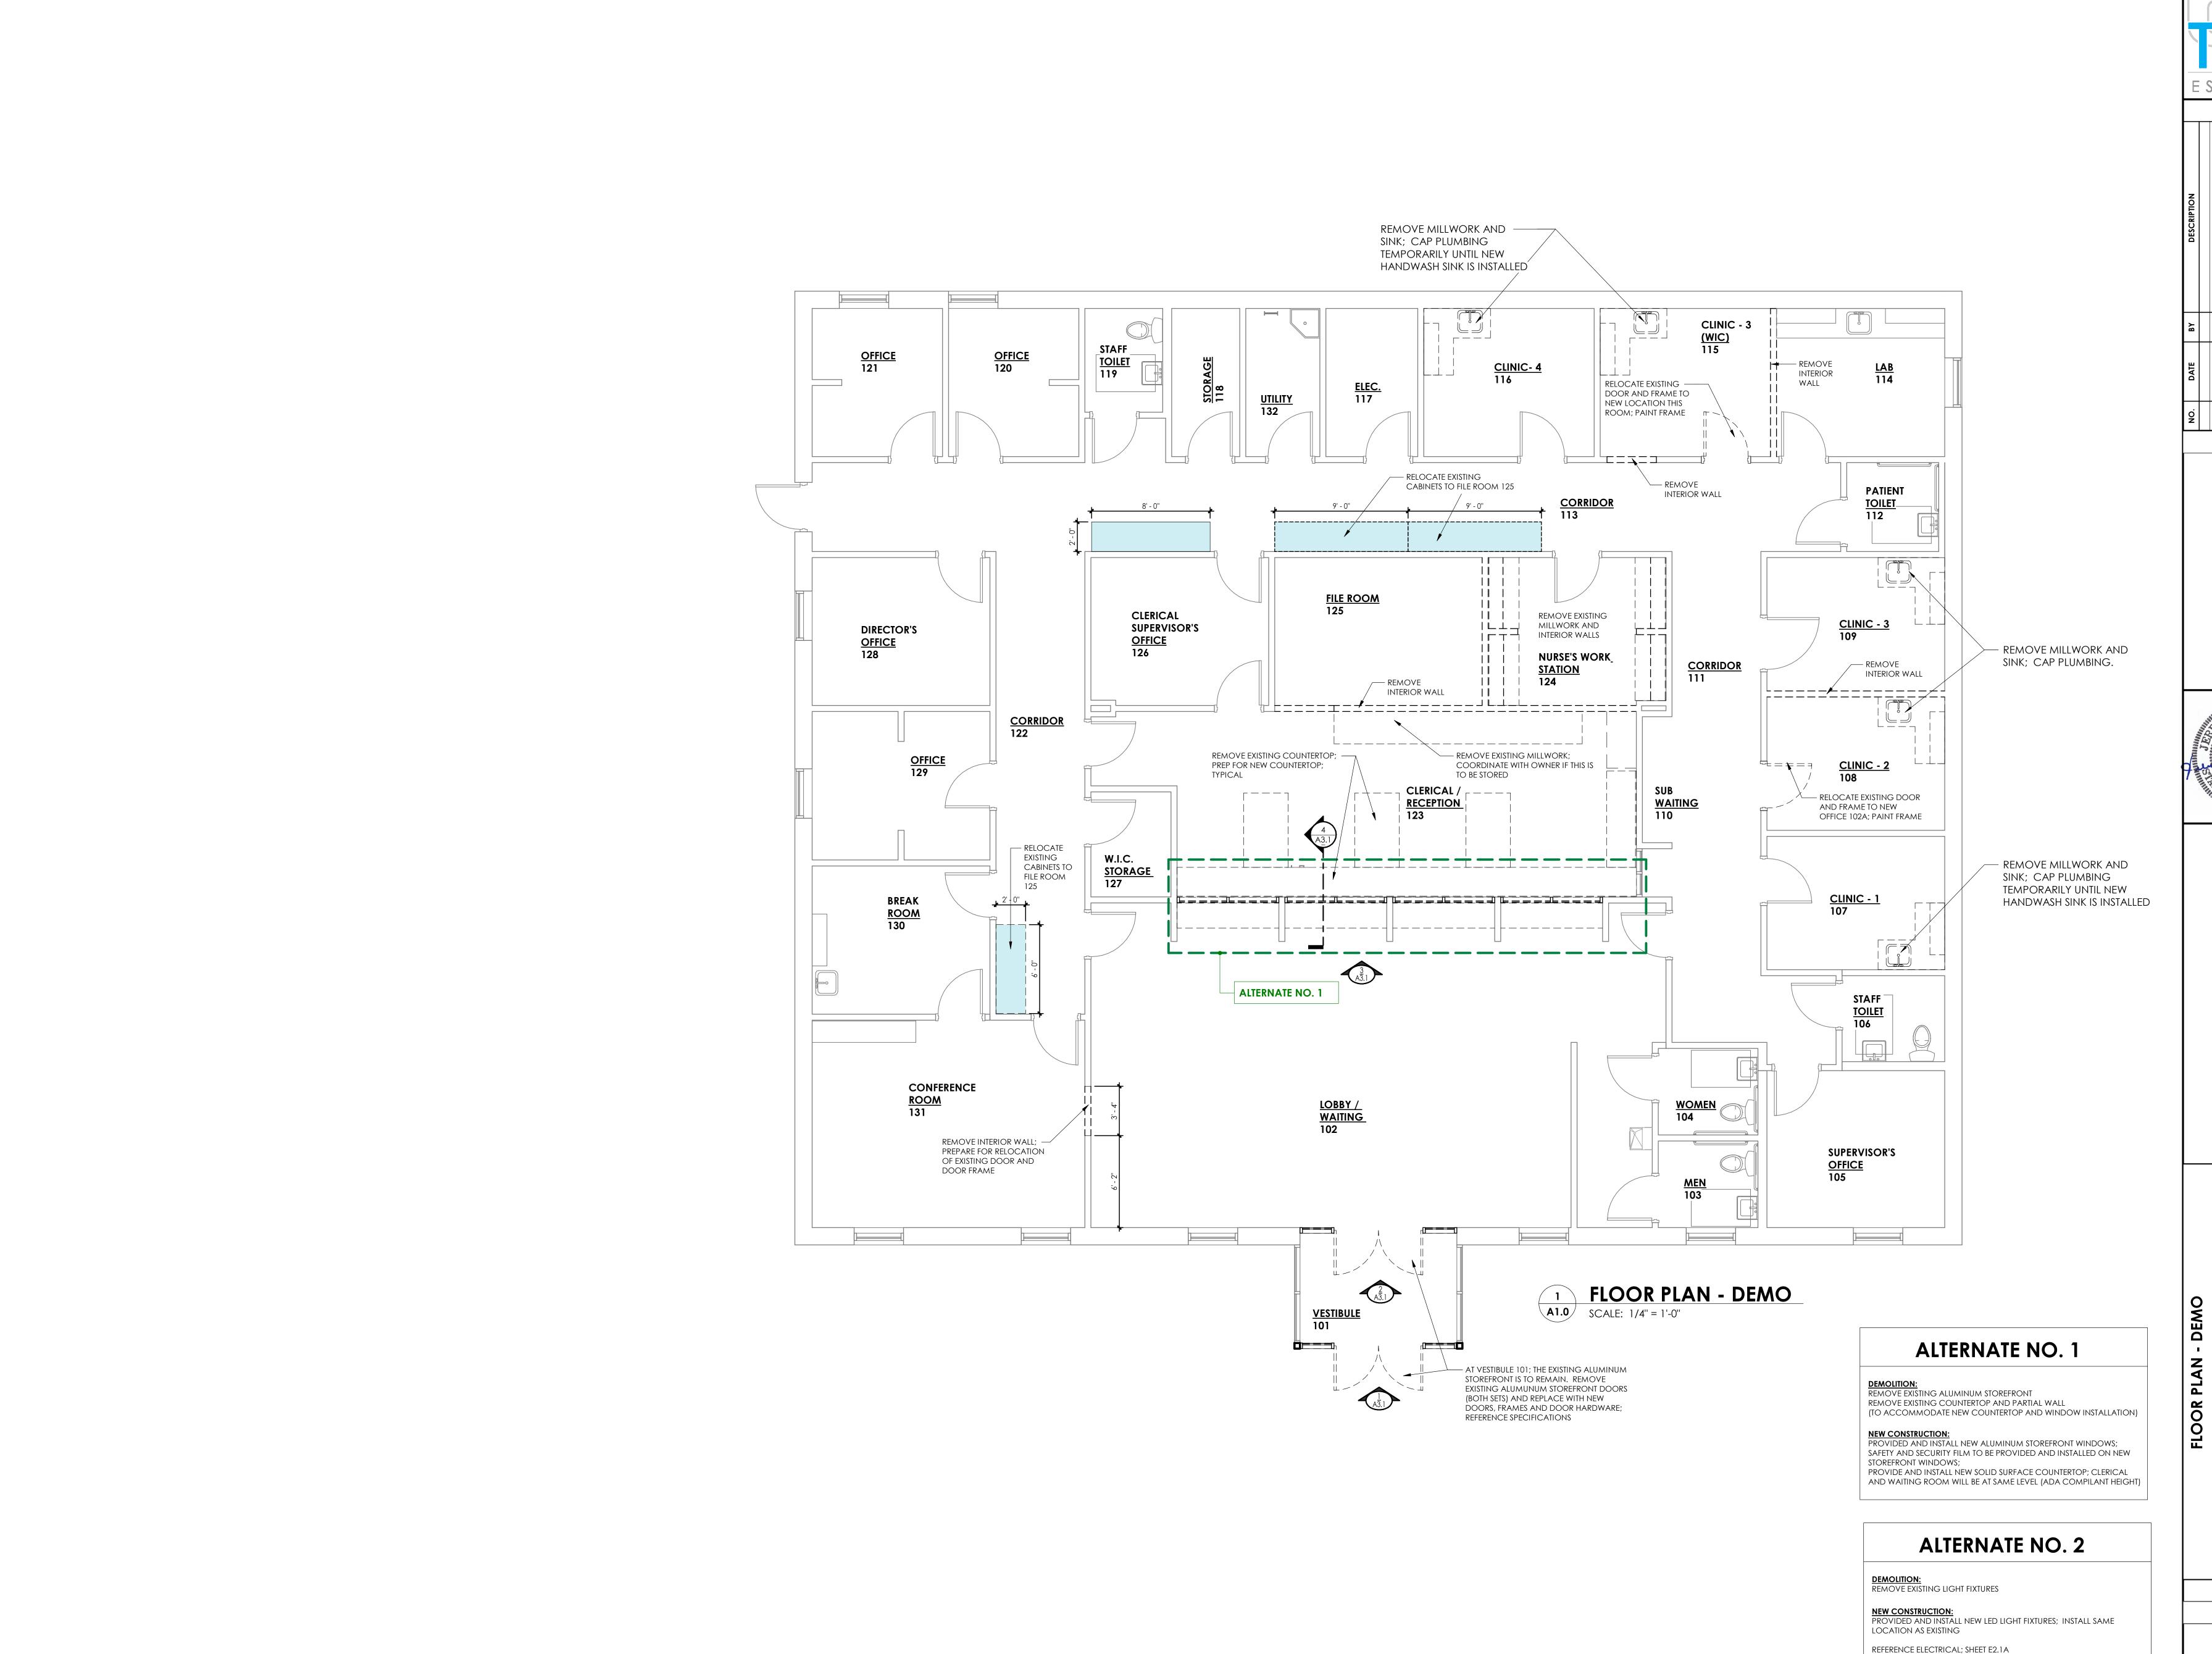
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A1.0

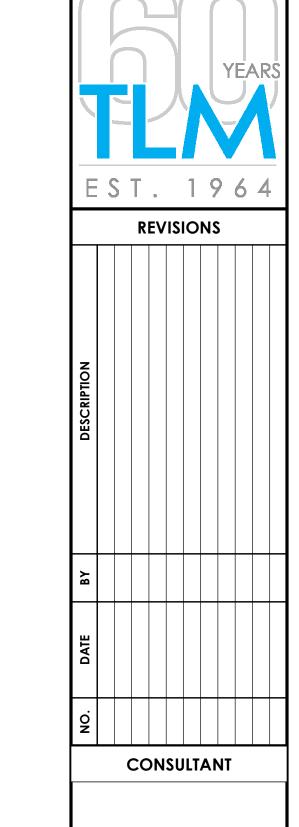

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Health Department Services of Services of

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JUNE 13, 2024

J-7087

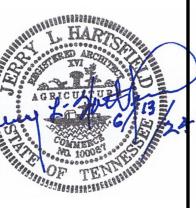A1.1





	PAII	NT LEGEND
PT-1	MAIN WALL PAINT	Sherwin Williams 7570 egret white
PT-2	DOOR FRAME & TRIM	Sherwin Williams 9173 Shiitake
PT-3	CEILING	Sherwin Williams 7551 Greek Villa


FINISH FLOOR LEGEND

LVT	
EPOXY	

TRANSITION LEGEND

1S-1 IVI I() FP()XY	JOHNSONITE CD-TA3 COLOR: CASTAWAY
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**NOTE: 4" COVE RUBBER BASE TO BE JOHNSONITE IN COLOR TA3 CASTAWAY.

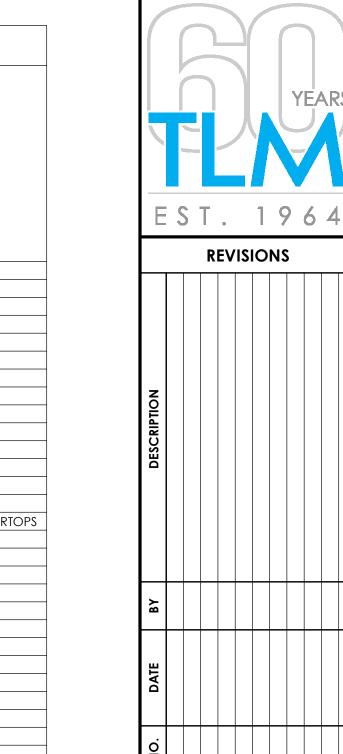

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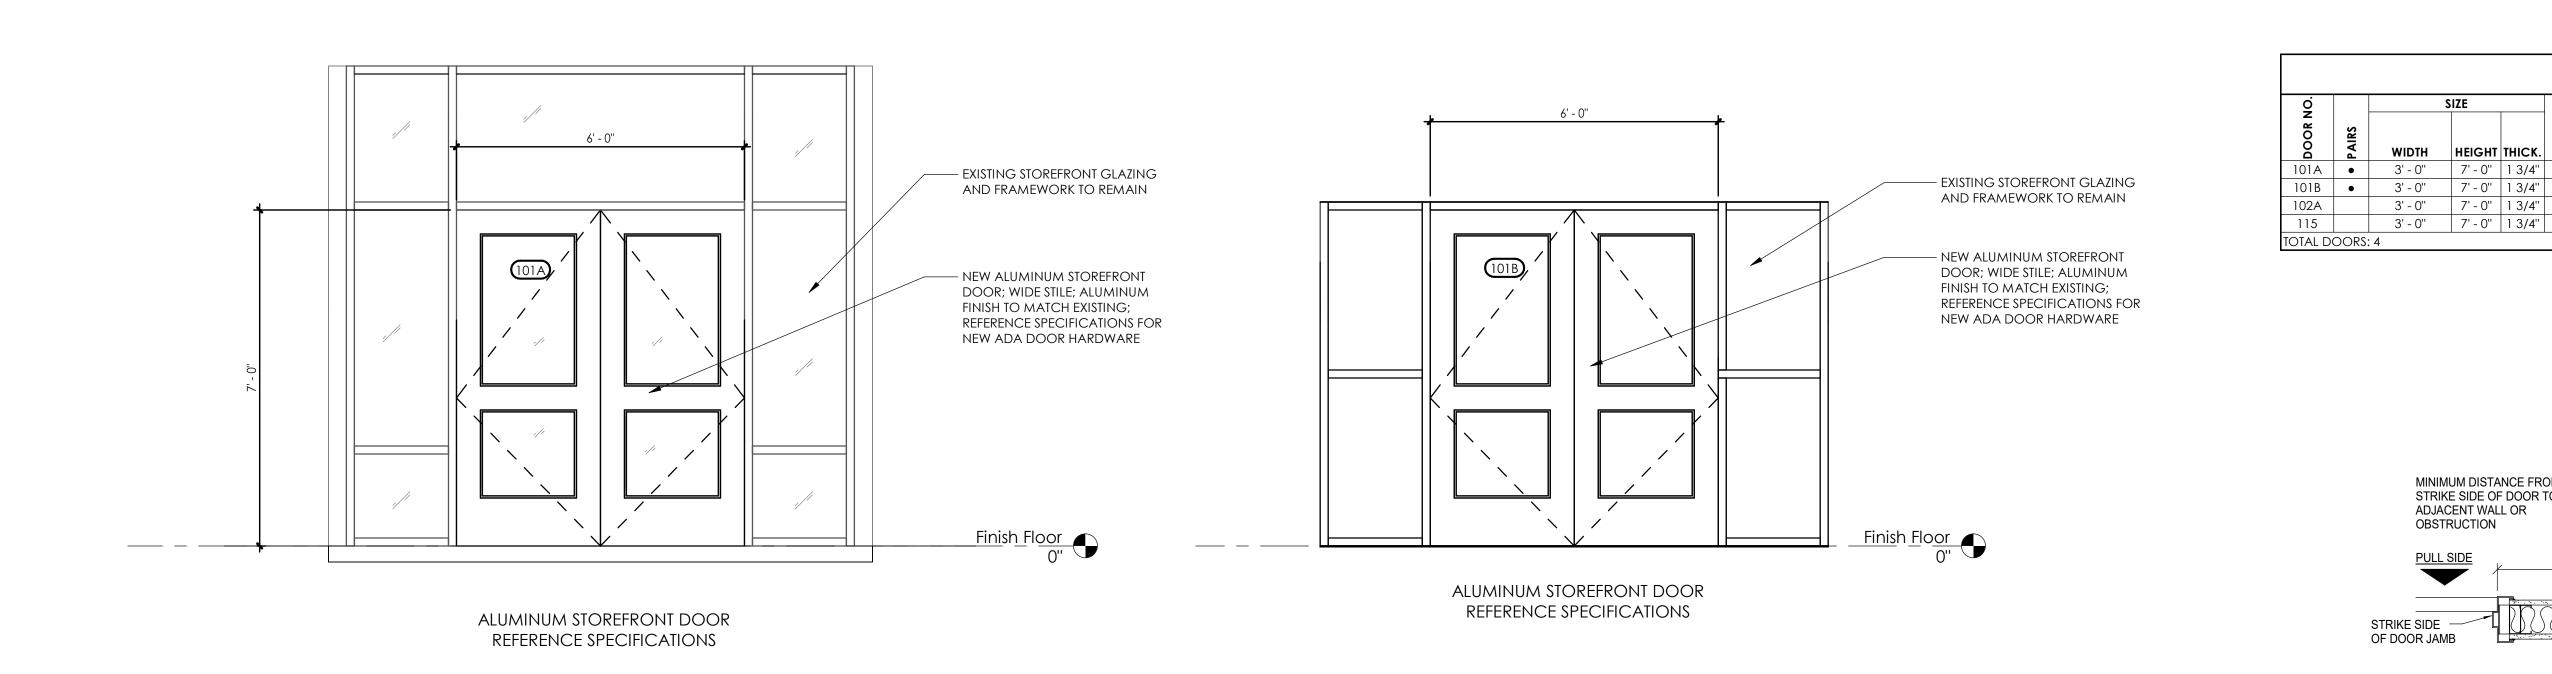
117 East LaFayette Street Jackson, Tennessee

nan County Health Department
INTERIOR RENOVATION
FOR
HICKMAN COUNTY
Centerville, Tennessee

JUNE 13, 2024

A2.1

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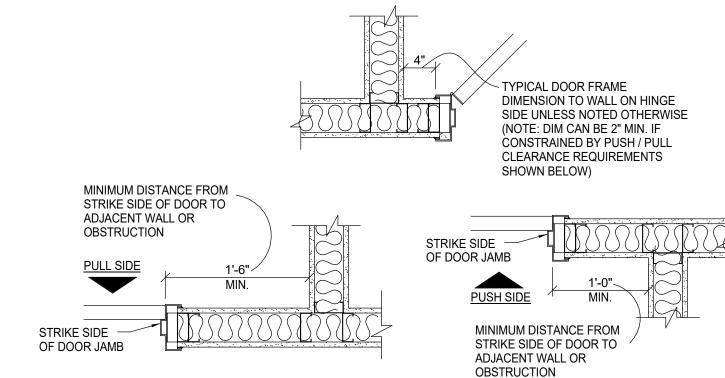
2 DOOR 100A - ELEVATION
SCALE: 1/2" = 1'-0"

CONTRACTOR TO INSTALL STENCIL LETTERING;


AFTER COMPLETION OF NEW FINISHES

1 DOOR 100 ELEVATION

A3.1 SCALE: 1/2" = 1'-0"





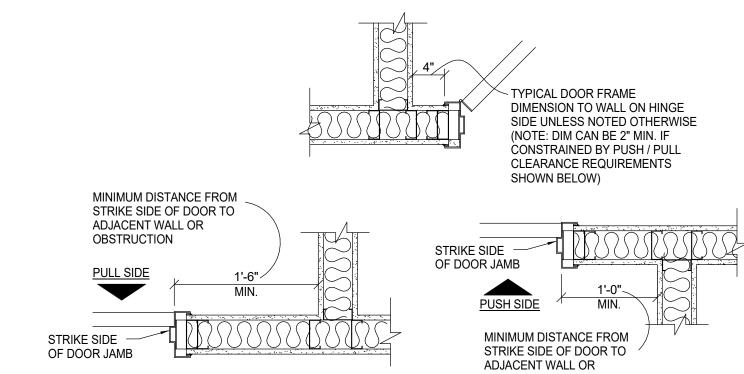


ELEV/ ELEV/ WIDTH HEIGHT THICK. TYPE TYPE HEAD JAMB SILL

Door Schedule

2.0 | 101B

REMARKS

102A DOOR, FRAME AND HARDWARE TO BE RELOCATED AND REINSTALLED 115 DOOR, FRAME AND HARDWARE TO BE RELOCATED AND REINSTALLED

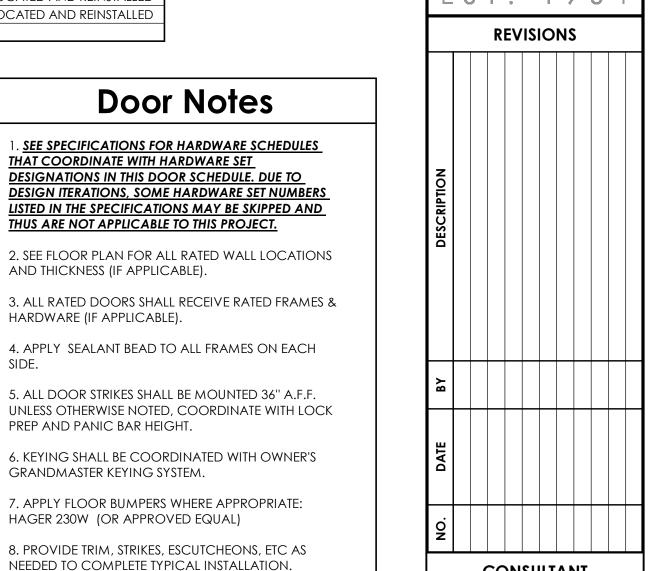

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18. ALL GLASS LITES IN WOOD DOORS SHALL BE IN METAL FRAMES. ALL DOOR GLASS LITE METAL FRAMES SHALL BE PAINTED. PAINT COLOR SHALL BE AS SELECTED BY THE ARCHITECT FROM A FULL RANGE PALETTE OF COLORS.

Door Notes

THAT COORDINATE WITH HARDWARE SET

AND THICKNESS (IF APPLICABLE).

HARDWARE (IF APPLICABLE).

PREP AND PANIC BAR HEIGHT.

GRANDMASTER KEYING SYSTEM.

STICK ON'S ALLOWED)

HANDICAP CODE.

HAGER 230W (OR APPROVED EQUAL)

9. PROVIDE KNURLED (TACTILE) SURFACE ALL AROUND LEVER HANDLES ON SPECIFIC DOORS IDENTIFIED. (NO

10. ADJUST INTERIOR DOOR CLOSERS TO 5 LBS PULL INTERIOR PRESSURE AND 8 LBS AT EXTERIOR DOORS PER

11. ALUMINUM GLASS DOORS: ALL HARDWARE SHALL CONFORM TO ANSI/BHMA GRADE 1, AND SHALL BE SUPPLIED BY THE DOOR MFR (INCLUDING HINGES, LOCKSETS, PANICS, TRIM, CLOSERS, WEATHER-STRIPPING, THRESHOLDS, ETC.). SEE HARDWARE SCHEDULE IN SPECIFICATIONS FOR ADDITONAL REQUIRED HARDWARE FOR ALUMINUM GLASS DOORS.

12. EXTERIOR H.M. DOORS & FRAMES SHALL BE INSULATED, GALVANIZED & FIELD PAINTED.

13. REFER TO FINISH SCHEDULE, MILLWORK, AND DETAILS FOR WOOD CASING AND TRIM FINISHES.

14. GLAZING IN NON-RATED DOORS, SLIDING DOORS,

STORM DOORS, WITHIN 24 INCHES OF DOORS, WITHIN

18 INCHES ABOVE FINISHED FLOOR AND EXCEEDING 9 SQ. FEET WITHING 36 INCHES OF WALKING SURFACE MUST BE SAFETY GLAZED, TEMPERED, AND PASS THE

TEST REQUIREMENTS OF CPSC 16-CFR, PART 1201 AND

15. FILL ALL DRYWALL JAMBS WITH DRYWALL MUD AT

16.ALL DRYWALL FRAMES SHALL HAVE A DRYWALL THROAT 1/8" WIDER THAN WALL THICKNESS

DRAWINGS ARE AN INDICATION THAT A LINTEL EXISTS. REFER TO STRUCTURAL DRAWINGS FOR SPECIFIC LINTEL


17. LINTELS SHOWN ON ALL ARCHITECTURAL

COMPLY WITH ANSI Z97.1


FRAME ANCHOR LOCATIONS

REQUIREMENTS AT ALL OPENINGS.

19. SEE MECHANICAL PLANS FOR DOORS REQUIRING UNDER-CUTTING FOR MECHANICAL AIRFLOW.

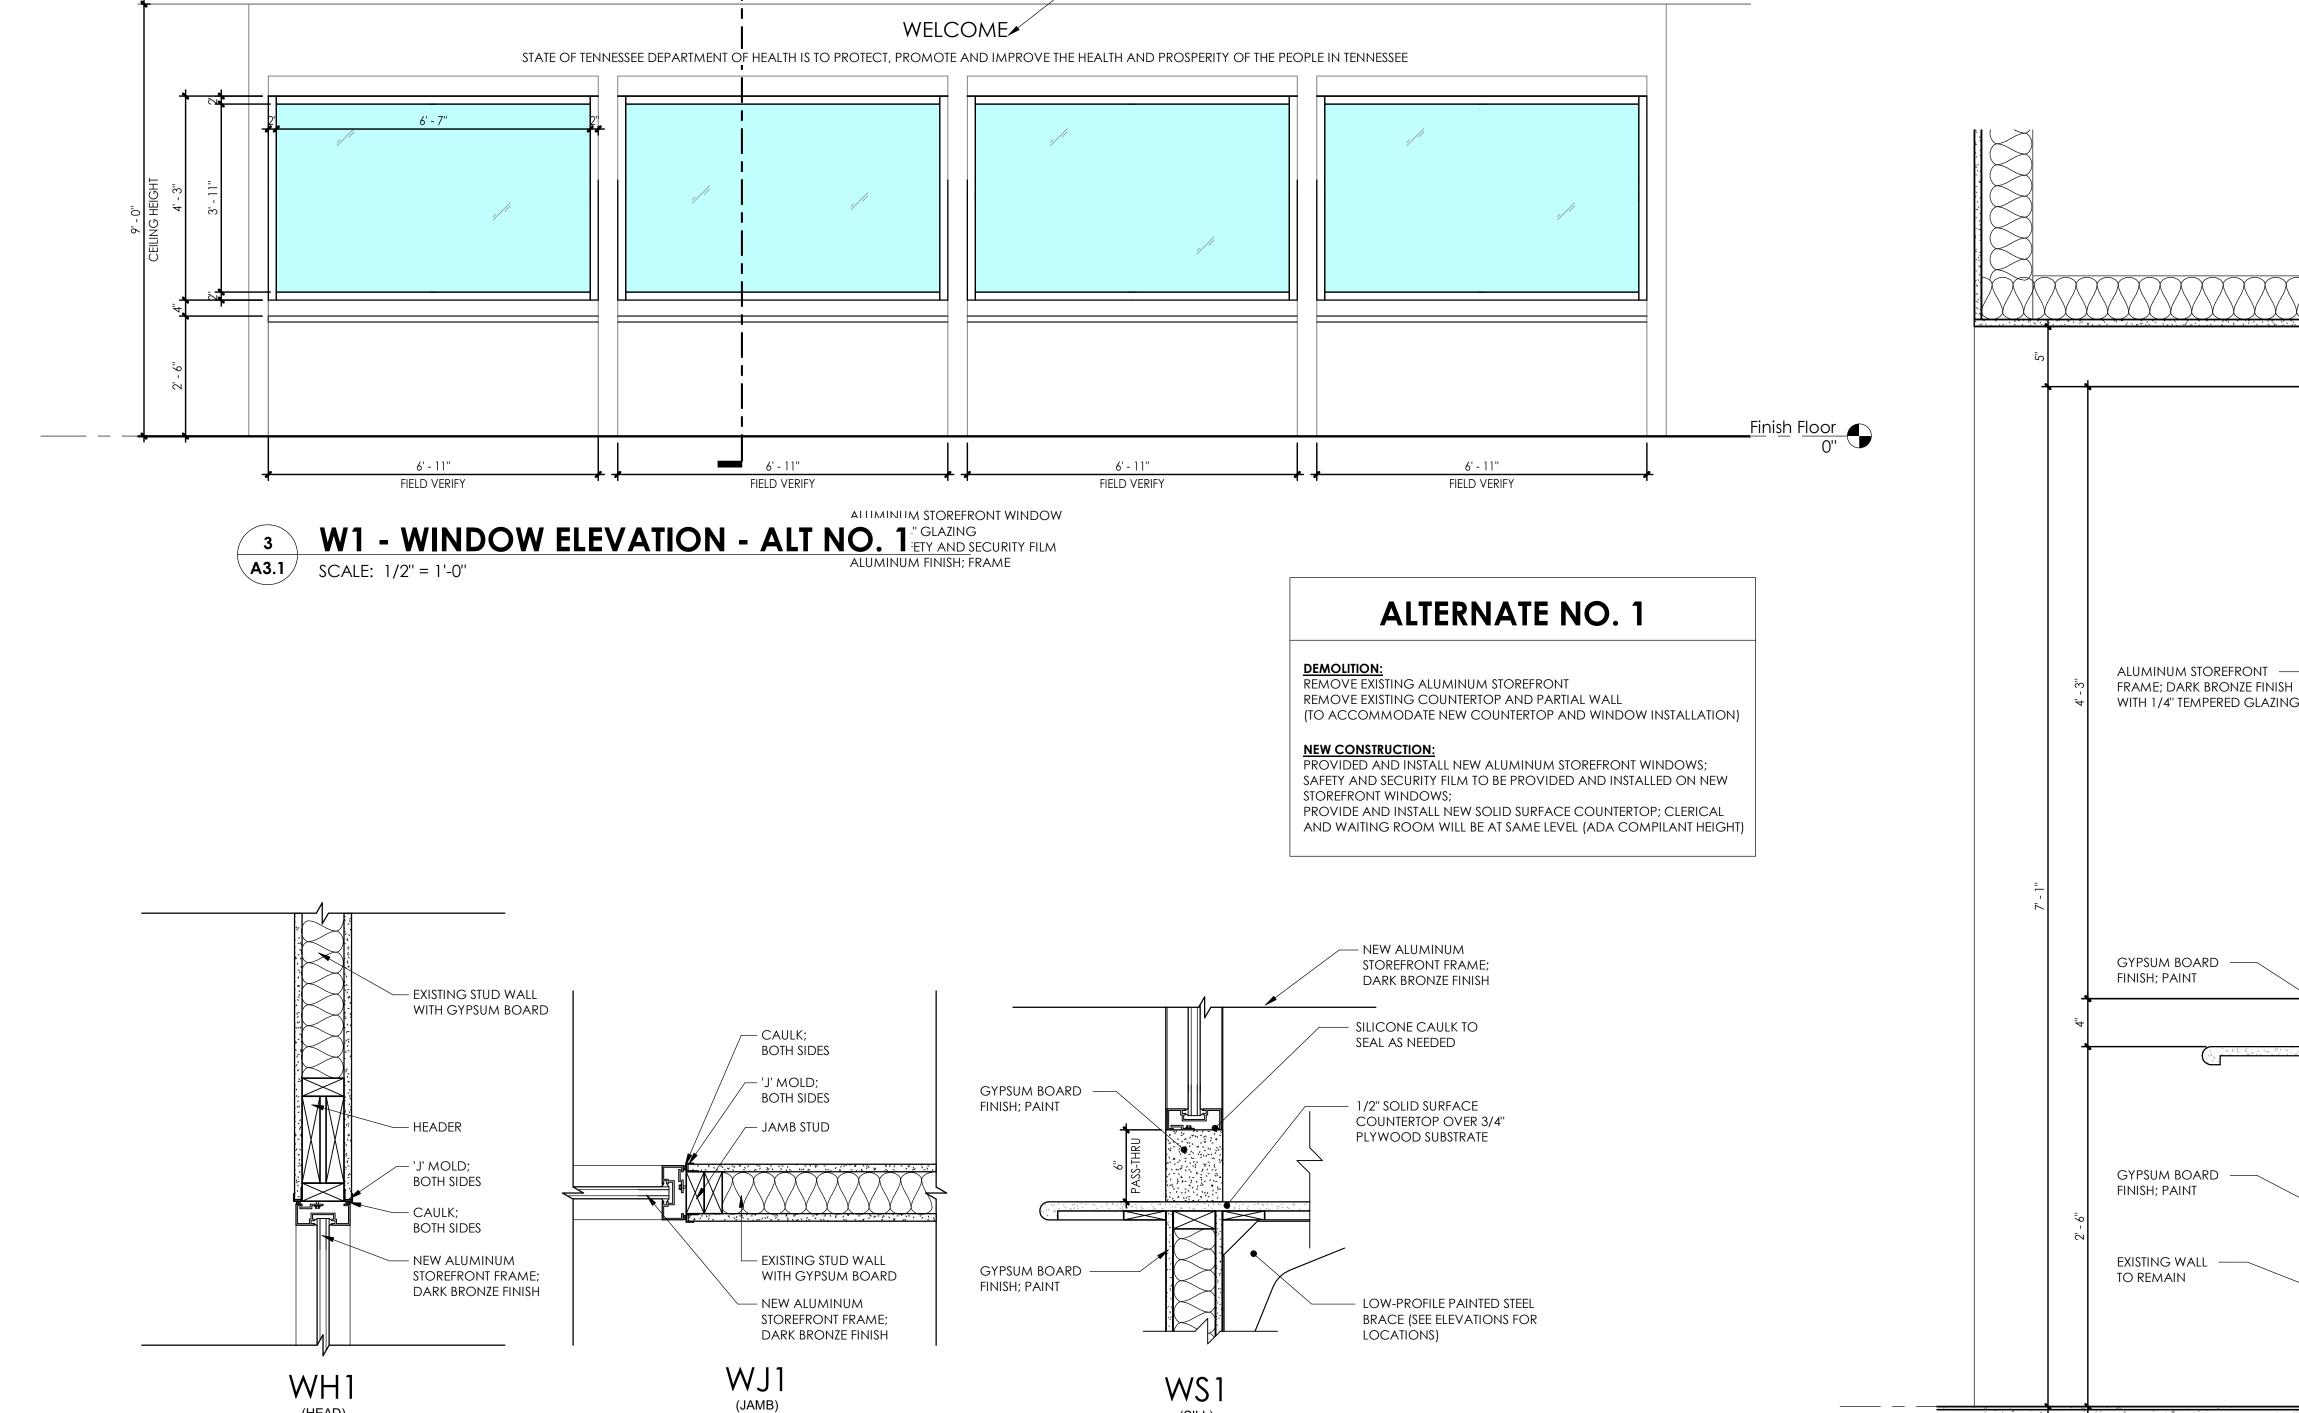

(SILL)

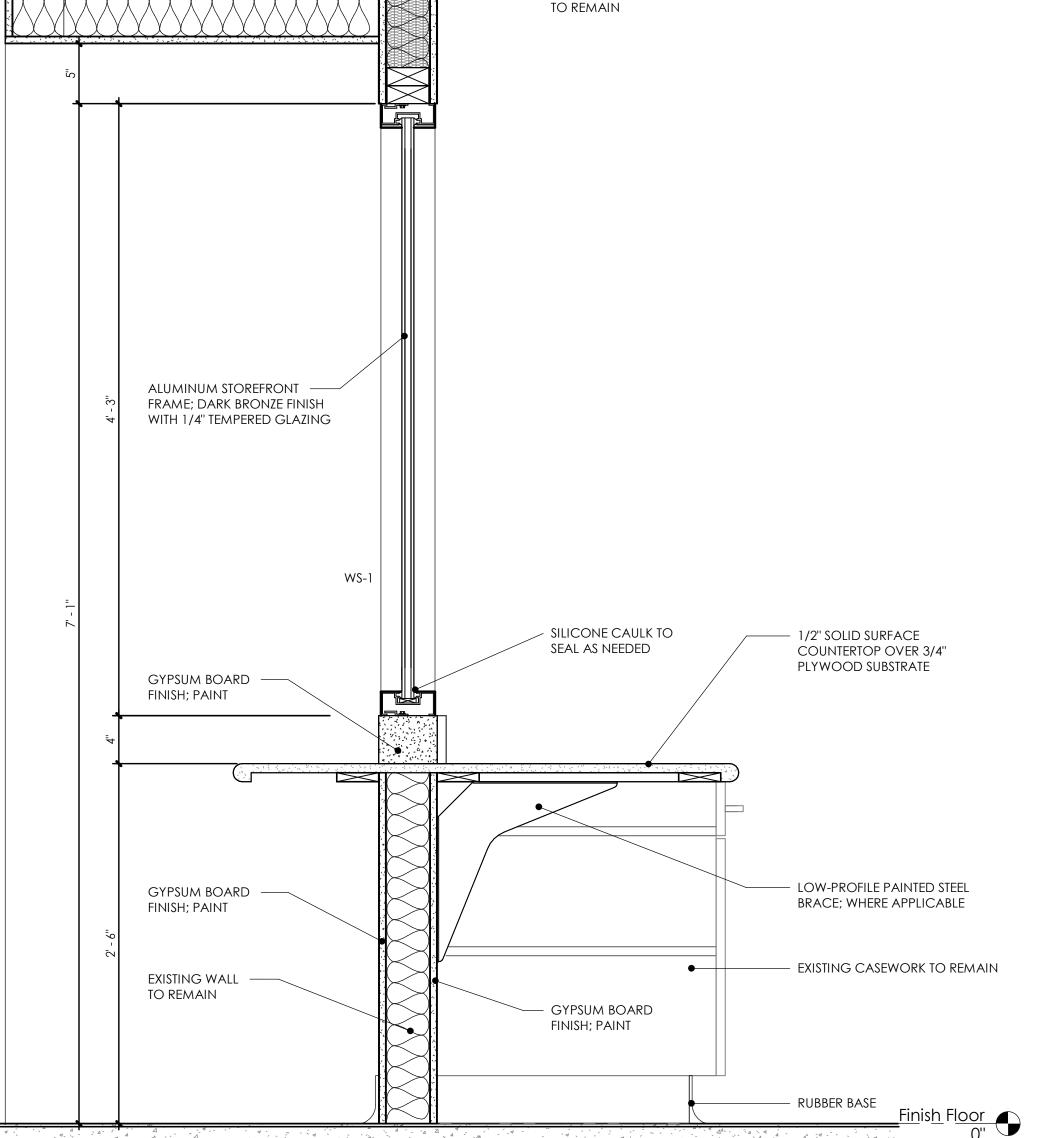

EXISTING WALL

DOORS

JUNE 13, 2024 J-7087

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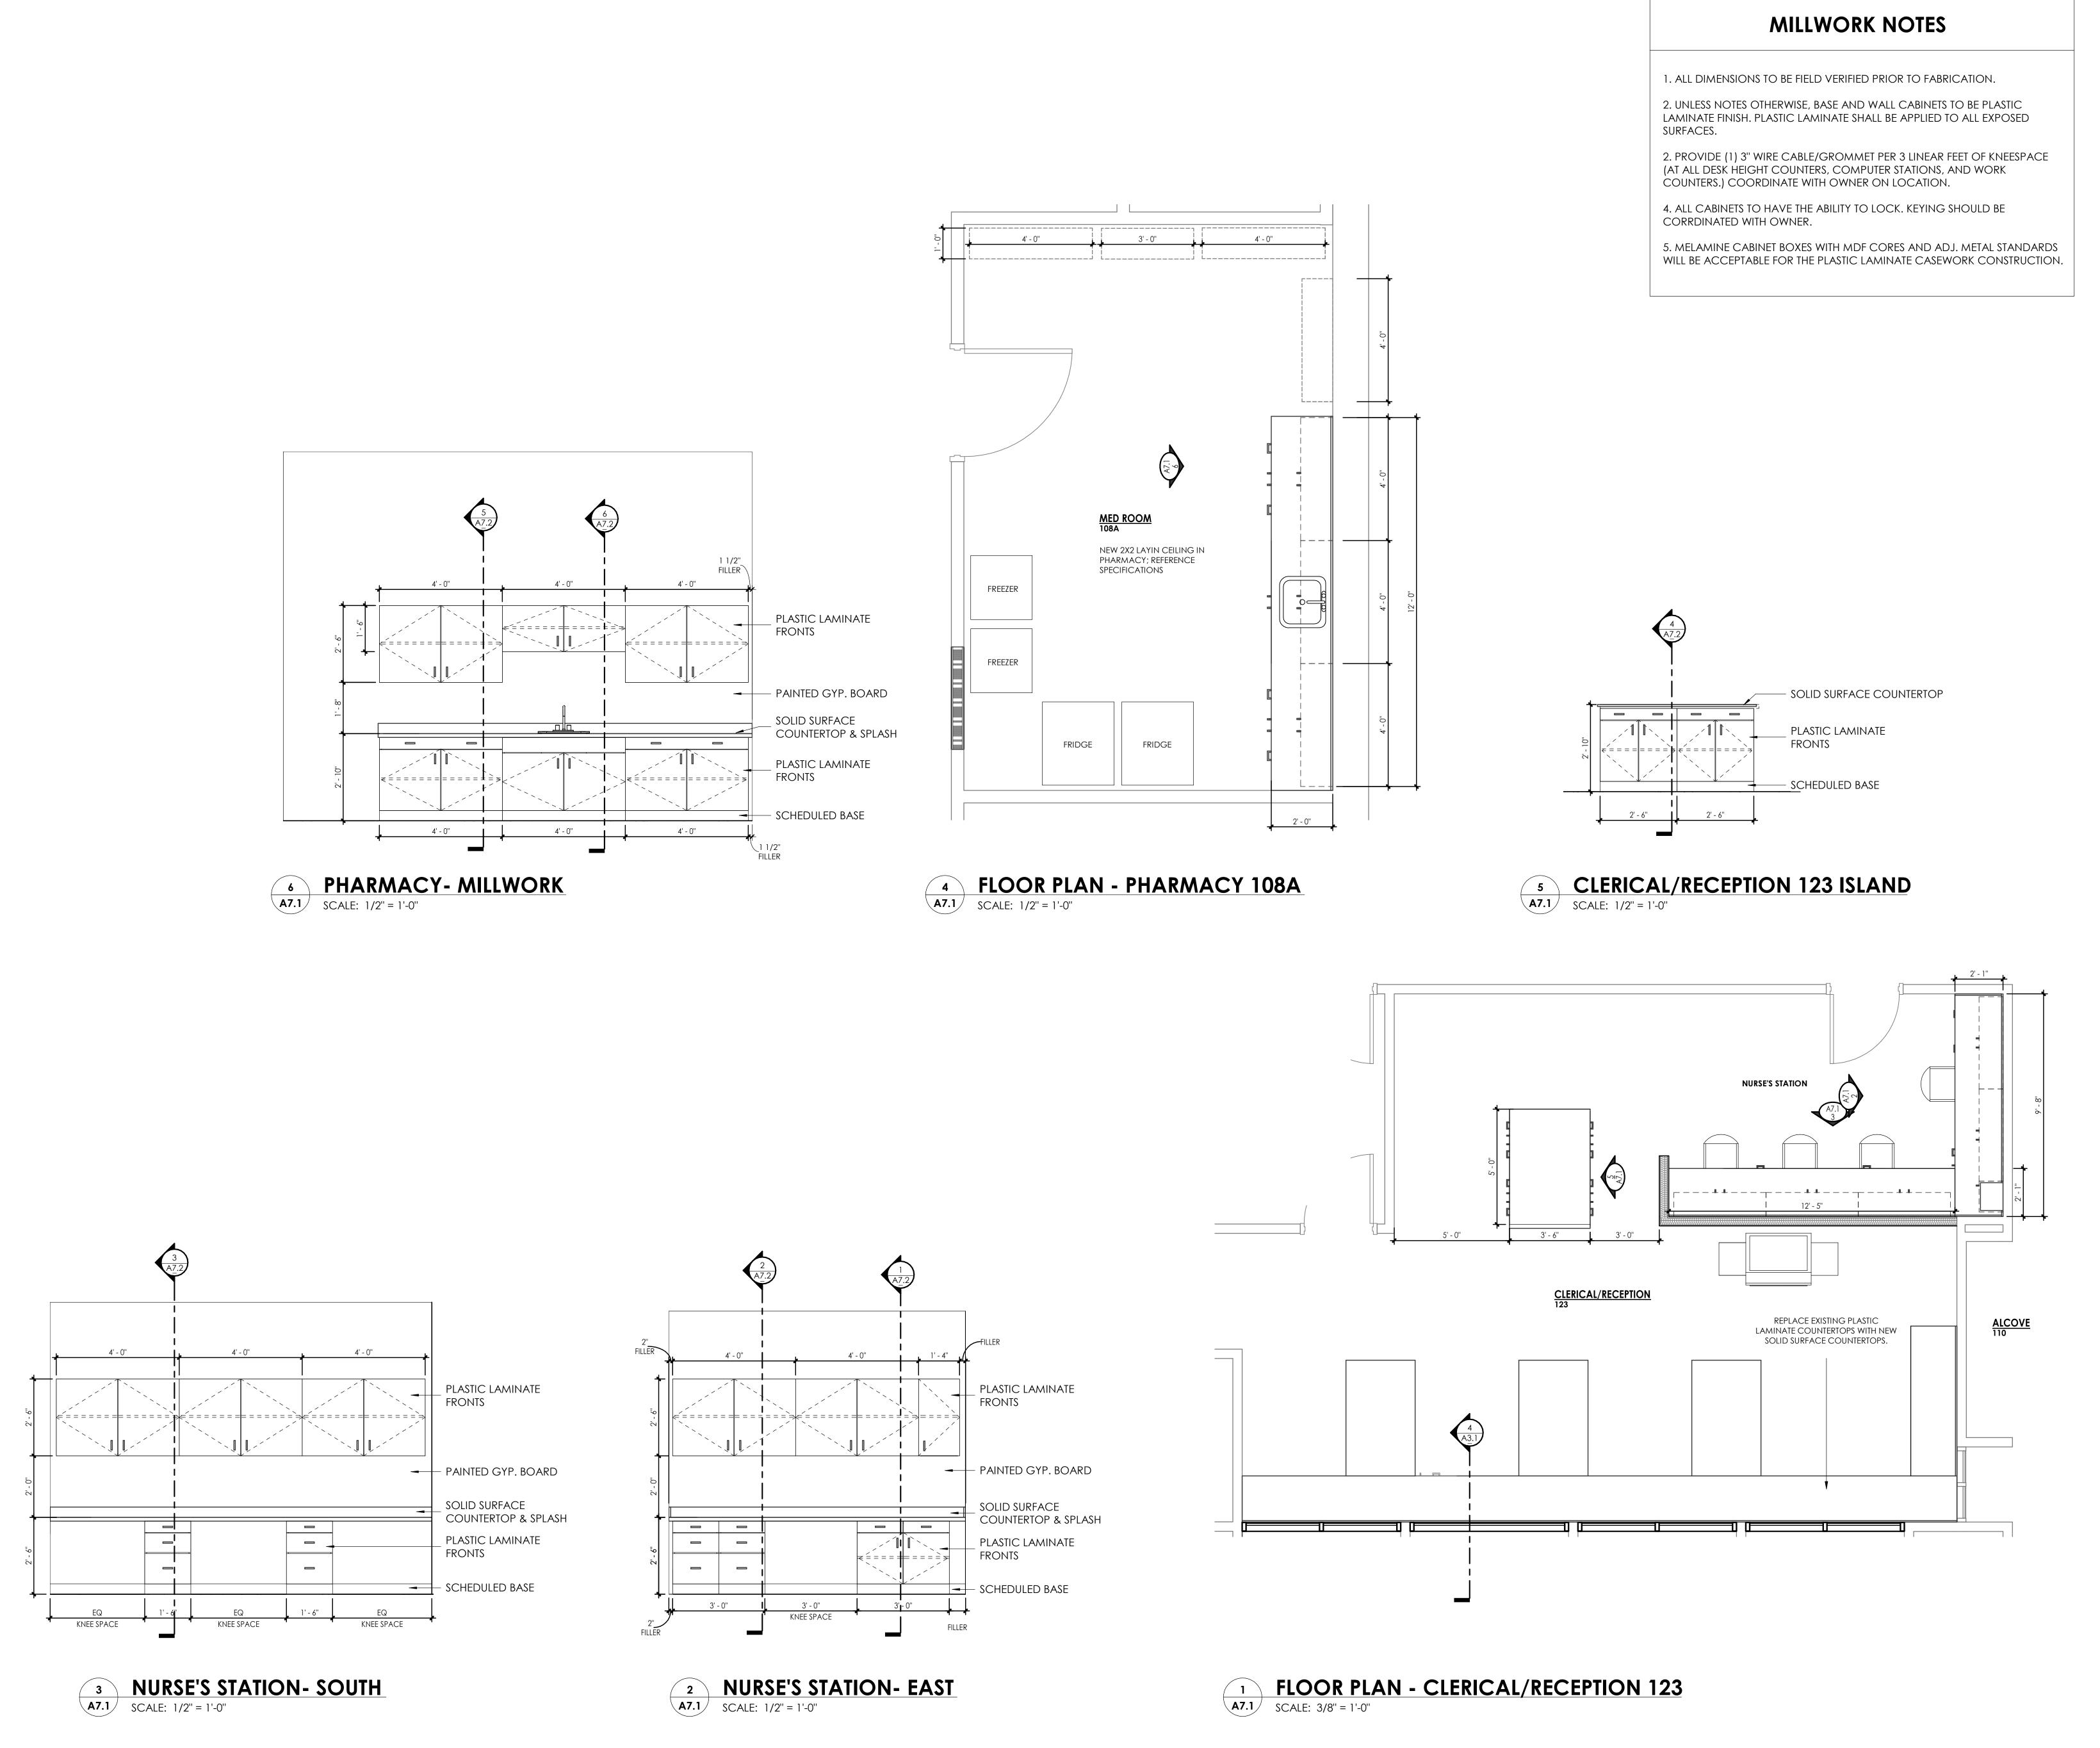
A3.1

6 WINDOW DETAILS - ADD ALT. NO. 1

(HEAD)

A3.1 SCALE: 1 1/2" = 1'-0"

4 W1 - WINDOW SECTION - ALT NO. 1
SCALE: 1 1/2" = 1'-0"



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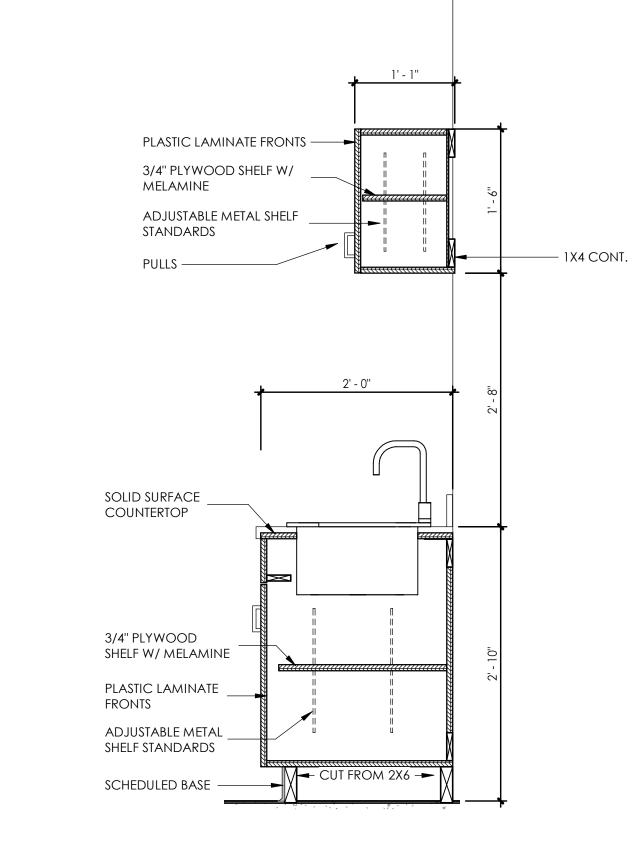
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man County Health Departme INTERIOR RENOVATION FOR HICKMAN COUNTY Centerville, Tennessee MILLWORK ELEVATIONS


JUNE 13, 2024


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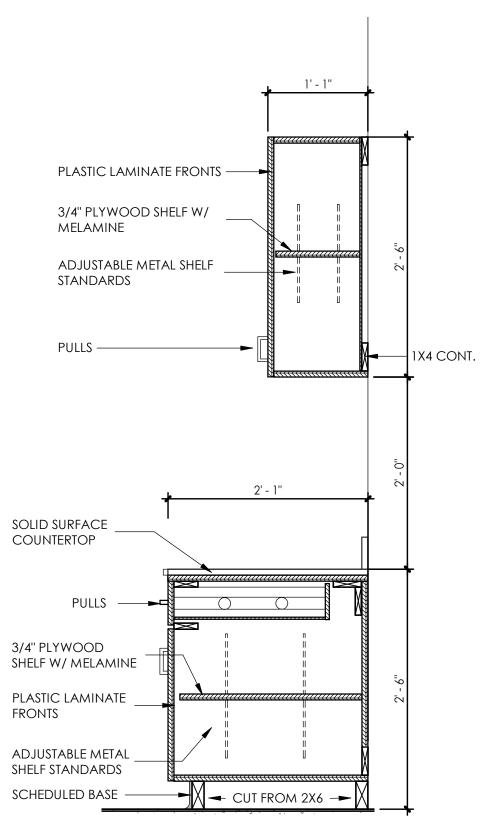
A7.1










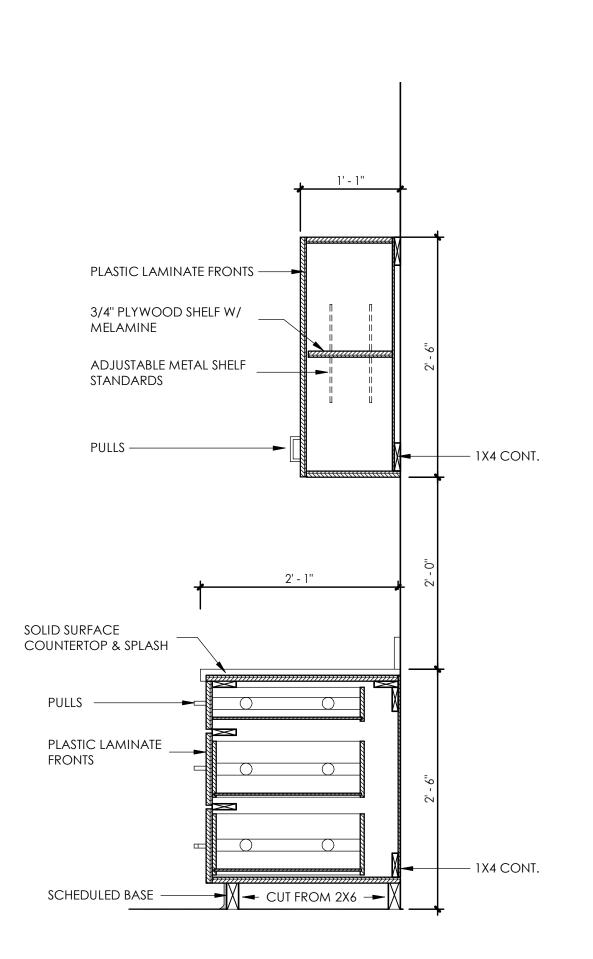

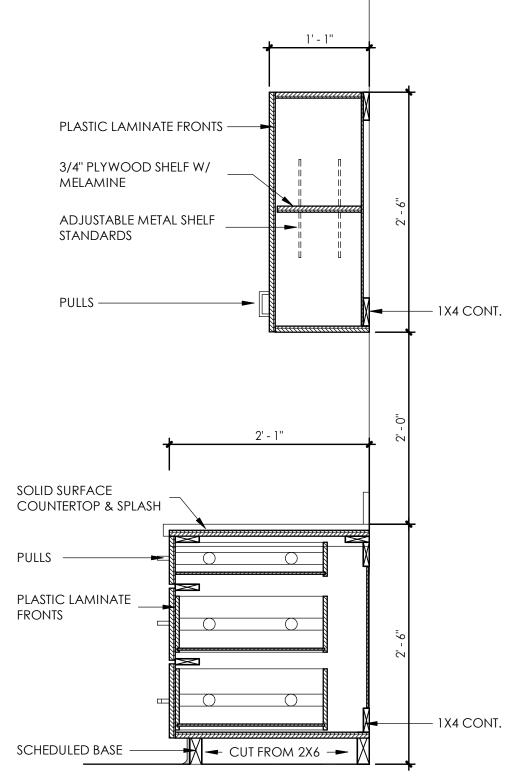


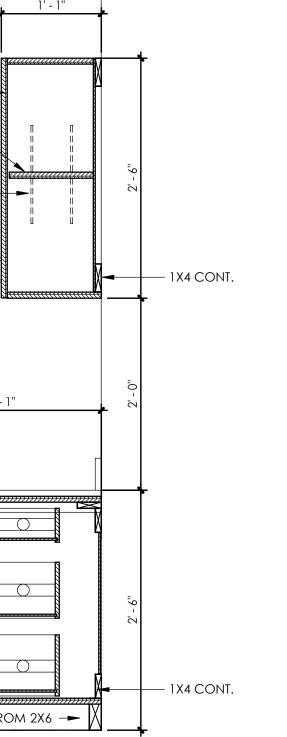

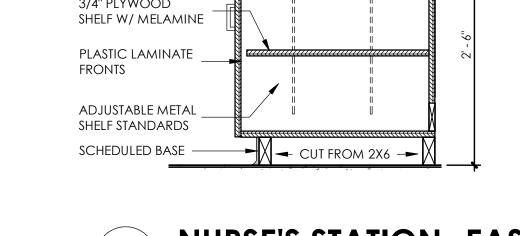

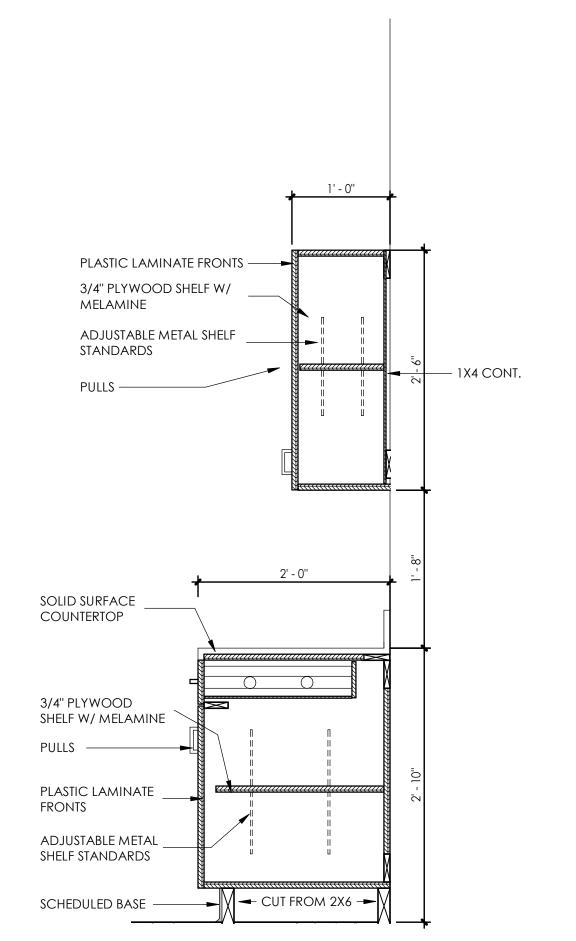

5 PHARMACY MILLWORK- 1
SCALE: 1" = 1'-0"

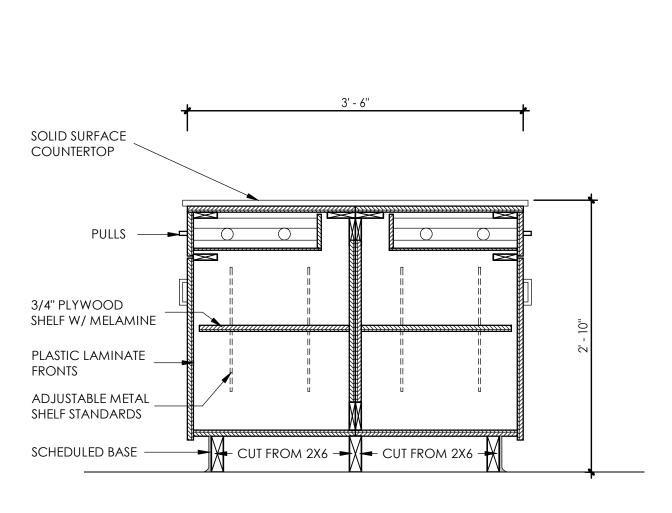









JUNE 13, 2024 J-7087 **A7.2**

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HVAC NOTES

- 1 ALL WORK SHALL BE DONE IN ACCORDANCE WITH THE LOCAL STATE, FEDERAL BUILDING CODE AND STATE HEALTH REGULATIONS AS WELL AS ANY APPLICABLE LOCAL REQUIREMENTS.
- 2 THESE DRAWINGS ARE DIAGRAMMATIC AND ARE NOT SHOP DRAWINGS. THIS CONTRACTOR SHALL FIELD VERIFY EXISTING CONDITIONS BEFORE FABRICATION OF DUCTWORK OR PIPING AND PROVIDE NECESSARY OFFSETS AND APPURTENANCES IN DUCTWORK AND PIPING TO AVOID ALL OBSTRUCTIONS.
 - 3 ALL MATERIALS SHALL BE NEW AND OF THE FINEST QUALITY.
- 4 ALL WORK SHALL BE PERFORMED BY TRADESMEN THAT ARE TRAINED AND HIGHLY SKILLED IN THE WORK THAT THEY ARE TO PERFORM. 5 ALL EQUIPMENT, MATERIALS, AND LABOR FURNISHED BY THIS CONTRACTOR SHALL BE WARRANTED BY HIM FOR A PERIOD OF ONE YEAR FROM THE DATE OF
- 6 HVAC CONTRACTOR SHALL COORDINATE WITH ELECTRICAL CONTRACTOR ALL VOLTAGES, ELECTRICAL LOADS, ETC. OF ELECTRICALLY OPERATED EQUIPMENT PRIOR TO ORDERING. ALL WIRING BY ELECTRICAL CONTRACTOR. DISCONNECT FOR PACKAGED AIR CONDITIONERS SHALL BE SUPPLIED AND INSTALLED BY ELECTRICAL CONTRACTOR.
- 7 THE CONTRACTOR SHALL SECURE AND PAY FOR ALL NECESSARY PERMITS, INSPECTIONS, ETC.
- 8 CONTRACTOR SHALL BE RESPONSIBLE FOR ALL SITE COORDINATION.
- 9 ROUTE ALL DUCTWORK PARALLEL AND PERPENDICULAR TO BUILDING LINES. DUCTWORK SHALL BE HUNG LEVEL AND FREE OF BENDS, CRIMPS AND SAGS. 10 DUCTWORK SHALL BE CONSTRUCTED OF PRIME GALVANIZED SHEET METAL; USE OF FIBERGLASS DUCTBOARD IS NOT ACCEPTABLE. ALL JOINTS SHALL BE SEALED WITH HIGH-PRESSURE DUCT SEALANT. PROVIDE TURNING VANES AT ALL ELBOWS AND OFFSETS. ALL DUCTWORK SHALL BE ROUTED CONCEALED AND SHALL BE SECURELY SUPPORTED FROM THE BUILDING STRUCTURAL ELEMENTS.
- 11 ALL INSULATED DUCTWORK SHALL HAVE EXTERNAL WRAP OR INTERNAL LINER. DUCT SIZES SHOWN ON THE DRAWINGS ARE CLEAR AIR DIMENSIONS AND HAVE NOT BEEN ADJUSTED FOR INTERNAL LINER. EXPOSED DUCT SHALL BE PAINT GRIP DOUBLE WALL SPIRAL DUCT WITH FIBERGLASS INSULATION BETWEEN
- 12 CONSTRUCT ALL SUPPLY AIR DUCTWORK IN ACCORDANCE WITH SMACNA STANDARDS FOR 2" PRESSURE CATEGORY. CONSTRUCT ALL RETURN AIR DUCTWORK IN ACCORDANCE WITH SMACNA STANDARDS FOR 1" PRESSURE CATEGORY.
- 13 LIMIT LENGTHS OF FLEXIBLE DUCTWORK TO 6'0" OR LESS. 14 ALL DUCTWORK LOCATED OUTSIDE OF THE BUILDING ENVELOPE, INCLUDING UNINSULATED ATTIC OR MEZZANINE SPACES, SHALL BE INSULATED WITH
- MINIMUM R-8 INSULATION. DUCTWORK LOCATED IN UNCONDITIONED SPACES WITHIN THE BUILDING ENVELOPE SHALL BE INSULATED WITH MINIMUM R-6 INSULATION. DUCTWORK LOCATED IN CONDITIONED SPACES, INCLUDING CEILING SPACES USED AS RETURN AIR PLENUMS SHALL BE INSULATED FOR CONDENSATION CONTROL ONLY.
- 15 SEAL ALL LONGITUDINAL AND TRANSVERSE SEAMS BEFORE APPLYING INSULATION. 16 EXPOSED DUCT SHALL BE FABRICATED USING "PAINT GRIP" GALVANIZING.
- 17 PROVIDE DEEP SEAL PVC CONDENSATE TRAPS ON AIR CONDITIONERS. IF ALLOWED BY LOCAL CODE, CONDENSATE PIPING SHALL BE ASTM D-2665, D-1785, SCHEDULE 40 PVC WITH PVC FITTINGS. JOINTS SHALL BE ASTM D-2855, SOLVENT WELDED WITH ASTM D-2564 SOLVENT CEMENT.
- 18 THE COMPLETED INSTALLATION SHALL BE IN ACCORDANCE WITH ALL UTILITY COMPANY REGULATIONS, APPLICABLE INDUSTRY STANDARDS OF GOOD
- PRACTICE AND SAFETY AND THE MANUFACTURERS' RECOMMENDATIONS FOR EQUIPMENT AND PRODUCT APPLICATION AND INSTALLATION. 19 THE CONTRACTOR SHALL VISIT THE SITE, OBSERVE EXISTING CONDITIONS AND VERIFY THAT THE WORK CAN BE INSTALLED IN ACCORDANCE WITH THE
- 20 SUBMIT PRODUCT DATA SHEETS AND SHOP DRAWINGS REPRESENTING THE WORK PROPOSED TO BE INSTALLED PRIOR TO THE ACTUAL INSTALLATION, FOR REVIEW AND COMMENT BY THE ARCHITECT. SHOP DRAWINGS SHALL SHOW ALL EQUIPMENT, MAINTENANCE CLEARANCE, ETC.
- 21 ALL PENETRATIONS THROUGH RATED WALLS OR FLOORS SHALL BE SEALED WITH AN APPROVED U.L. LISTED FIREPROOFING TO MAINTAIN THE INTEGRITY OF 22 THE CONTRACTOR SHALL TEST AND BALANCE THE NEW HVAC SYSTEMS AND SHALL SUBMIT COPIES OF TEST AND BALANCE REPORTS TO THE ENGINEER FOR
- 23 INSTALL SMOKE DETECTORS IN THE DUCTWORK AT AIR CONDITIONERS FOR FAN SHUTDOWN IN ACCORDANCE WITH CODE. 24 VERIFY THAT EACH PIECE OF EQUIPMENT OR SYSTEM HAS BEEN CHECKED FOR PROPER LUBRICATION, DRIVE ROTATION, BELT TENSION, CONTROL SEQUENCE
- OR FOR OTHER CONDITIONS WHICH MAY CAUSE DAMAGE.
- 25 DEMONSTRATE OPERATION AND MAINTENANCE OF PRODUCTS TO OWNER'S PERSONNEL ONE WEEK PRIOR TO DATE OF FINAL INSPECTION.
- 26 EXECUTE FINAL CLEANING PRIOR TO FINAL PROJECT ASSESSMENT.
- 27 LOCATE DUCTS AND EQUIPMENT WITH SUFFICIENT SPACE AROUND EQUIPMENT TO ALLOW NORMAL OPERATING AND MAINTENANCE ACTIVITIES.
- 28 PROVIDE CANVAS, FLAME RETARDANT DUCT CONNECTORS AT ALL CONNECTIONS OF EQUIPMENT TO DUCTWORK. 29 VERIFY FLOOR PLAN AND WALL/FLOOR/CEILING RATINGS WITH ARCHITECTURAL PLANS. PROVIDE RATED PENETRATIONS AT EACH INSTANCE WHERE
- MECHANICAL INSTALLATION PENETRATES A RATED ASSEMBLY. PENETRATIONS SHALL BE PER DETAILS ON DRAWINGS OR SOME OTHER U.L. LISTED DESIGN. 30 ALL SUPPLY AIR DIFFUSERS SHALL HAVE 4-WAY THROW UNLESS INDICATED OTHERWISE ON THE PLANS.
- 31 FRAME STYLE OF ALL AIR DISTRIBUTION DEVICES SHALL MATCH THE TYPE OF CEILING/WALL IN WHICH THEY ARE INSTALLED. VERIFY WITH ARCHITECTURAL
- 32 THE COLOR OF ALL AIR DISTRIBUTION DEVICES SHALL BE AS DIRECTED BY THE ARCHITECT. 33 COORDINATE WITH GENERAL CONTRACTOR ON SIZE AND LOCATION OF STURCTURAL SUPPORT OR CONCRETE PADS FOR ANY EQUIPMENT REQUIRING
- 34 USE EQUIVALENT SQUARE INCHES TO CHANGE DUCT DIMENSIONS OR CONSULT WITH MECHANICAL ENGINEER IF NEEDED. 35 DUCT PENETRATIONS THROUGH THE EXTERIOR WALL SHALL BE WEATHERPROOFED WITH FLASHING AND CAULK.
- 36 THE AIR CONDITIONING EQUIPMENT SHALL BE MANUFACTURED BY DAIKIN, YORK, CARRIER OR AN APPROVED EQUAL. THE EXHAUST FANS SHALL BE MANUFACTURED BY LOREN COOK, GREENHECK, AREOVENT OR AN APPROVED EQUAL.

	AIR DISTRIBUTION SCHE	DULE
MARK	DESCRIPTION	MODEL (EQUAL TO)
SAD-1	24"X24" CEILING SUPPLY DIFFUSER	NAILOR RNS3
RG-1	24"X24" CEILING RETURN GRILLE	NAILOR 4260




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PLUMBING NOTES

- 1 ALL WORK SHALL BE DONE IN ACCORDANCE WITH THE LOCAL, STATE, & FEDERAL BUILDING CODE AND STATE HEALTH REGULATIONS AS WELL AS ANY OTHER APPLICABLE LOCAL REQUIREMENTS.
- 2 ALL INSTALLATION MUST MEET THE APPLICABLE ENERGY CODE.
- 3 THESE DRAWINGS ARE DIAGRAMMATIC AND SHOW GENERAL PLUMBING LAYOUTS AND PIPE ROUTING FOR BIDDING 4 IT IS THE RESPONSIBILITY OF THE CONTRACTOR TO CONFIRM SPACE ALLOCATIONS.
- 5 ALL MATERIALS SHALL BE NEW AND OF THE FINEST QUALITY. ALL WORK SHALL BE PERFORMED BY TRADESMEN THAT ARE TRAINED AND HIGHLY SKILLED IN THE WORK THAT THEY ARE TO PERFORM. 6 ALL EQUIPMENT, MATERIALS, AND LABOR FURNISHED BY THIS CONTRACTOR SHALL BE WARRANTED BY HIM FOR A PERIOD OF ONE YEAR FROM THE DATE OF FINAL ACCEPTANCE.

8 USE MINIMUM 1/8" PER FT. SLOPE ON UNDERGROUND SANITARY SEWER LINE.

- 7 PVC-DWV (ASTM 2665) PIPE AND SOLVENT WELDED FITTINGS WITH ASTM D-2564 SOLVENT CEMENT SHALL BE USED FOR UNDERGROUND SEWER PIPE IF ALLOWED BY LOCAL CODES. SERVICE WEIGHT CAST IRON (ASTM A74) MAY BE USED IF LOCAL CODES DO NOT ALLOW PVC.
- 9 PROVIDE CLEANOUTS AT CHANGE IN DIRECTION AND AS REQUIRED INSIDE AND OUTSIDE OF BUILDING. 10 DOMESTIC WATER SHOWN ON PLANS TO RUN CONCEALED ABOVE CEILINGS WHERE THERE IS A CEILING. DOMESTIC WATER PIPE ABOVE GROUND SHALL BE COPPER TYPE L (UNLESS OTHERWISE STATED) WITH ½" (PIPE SIZES LESS THAN 3") OR 1" (PIPE SIZES GREATER THAN OR EQUAL TO 3") FIBERGLASS PAPER BACKED MOLDED INSULATION (ASTM Ć547) ON COLD WATER AND 1" (PIPE SIZES LESS THÁN 11/2") OR 11/2" (PIPE SIZES GREATER THAN OR EQUAL TO 11/2") FIBERGLASS PAPER BACKED MOLDED INSULATION ON HOT WATER. TAPE JOINTS IN INSULATION TO CREATE VAPOR TIGHT BARRIER. INSULATION TO MEET ENERGY CODE REQUIREMENTS.
- 11 UNDERGROUND WATER PIPING SHALL BE TYPE "K" COPPER OR SCHEDULE 40 PVC (ASTM D1785) (DO NOT INSTALL PVC UNDER SLAB), AS LOCAL CODES ALLOW.
- 12 ALL WATER LINES RUN IN EXTERIOR WALLS SHALL BE LOCATED BETWEEN INTERIOR GYPSUM AND INSULATION TO PREVENT FREEZING. INSULATE ALL WATER LINES IN EXTERIOR WALLS WITH 2" THICK INSULATION. EXTERIOR WALL BUILDING INSULATION SHALL COMPLETELY ENCOMPASS INSULATED PLUMBING PIPING WITHIN STUD CAVITY.
- 13 IT IS THE RESPONSIBILITY OF THE CONTRACTOR TO ENSURE THAT ALL WATER DISTRIBUTION PIPING IS ROUTED IN AREAS THAT ARE NOT SUBJECT TO FREEZING TEMPERATURES. IF PIPING IS SHOWN ROUTED IN SUCH AREAS AND NO PROVISION FOR FREEZE PROTECTION IS INDICATED, THE CONTRACTOR SHALL NOTIFY THE ARCHITECT/ENGINEER
- 14 PROVIDE ACCESSIBLE STOPS IN PIPING CONNECTIONS TO ALL PLUMBING FIXTURES. ALL HAND LAVATORIES DESIGNED AS HANDICAPPED WITH EXPOSED PIPING SHALL BE PROVIDED WITH INSULATION KITS COVERING SINK DRAINS AND SINK SUPPLIES.
- 15 PLUMBING CONTRACTOR SHALL COORDINATE WITH ELECTRICAL CONTRACTOR ALL VOLTAGES, ELECTRICAL LOADS, ETC. OF ELECTRICALLY OPERATED EQUIPMENT PRIOR TO ORDERING. ALL WIRING BY ELECTRICAL CONTRACTOR.
- 16 PLUMBING CONTRACTOR SHALL FURNISH ACCESS PANELS TO BE INSTALLED BY GENERAL CONTRACTOR AS REQUIRED FOR PLUMBING INSTALLATIONS.
- 17 SLEEVES SHALL BE INSTALLED WHERE PIPING PASSES THROUGH STRUCTURE. ALL PENETRATIONS THROUGH FIRE RATED WALLS AND FLOOR SHALL BE SEALED WITH AN APPROVED U.L. LISTED FIREPROOFING TO MAINTAIN THE INTEGRITY OF THE WALL OR FLOOR RATING.
- 18 PROVIDE MANUFACTURED COMPATIBLE PIPE HANGERS, RODS AND INSERTS, OR CLAMPS FOR THE PROPER SUPPORT OF ALL PIPING. NO BAND IRON, TIE WIRE, METAL STRAPPING OR WIRE STRAPPING WILL BE PERMITTED. INSTALL LATERAL AND LONGITUDINAL SEISMIC BRACING IF REQUIRED. PIPE VIBRATION AND/OR PIPE SWAY WILL NOT BE
- 19 ALL PIPING SHALL BE LABELED. ALL HOLES THROUGH CONCRETE SHALL BE CORE DRILLED. SAW CUT ALL CONCRETE AND ASPHALT BEFORE BREAKING AND REMOVING. FIELD LOCATE ALL EXISTING SERVICES PRIOR TO STARTING ANY
- 20 DEMONSTRATE OPERATION AND MAINTENANCE OF PRODUCTS TO OWNER'S PERSONNEL ONE WEEK PRIOR TO DATE OF FINAL INSPECTION. EXECUTE FINAL CLEANING PRIOR TO FINAL PROJECT ASSESSMENT.
- 21 PROVIDE SUPPORT AND EQUIPMENT REQUIRED TO CONTROL EXPANSION AND CONTRACTION OF PIPING. PROVIDE LOOPS, PIPE OFFSETS, SWING JOINTS AND EXPANSION JOINTS WHERE REQUIRED.

23 ENSURE EXTERIOR WALL CHASES ARE INSULATED TO PREVENT FREEZING.

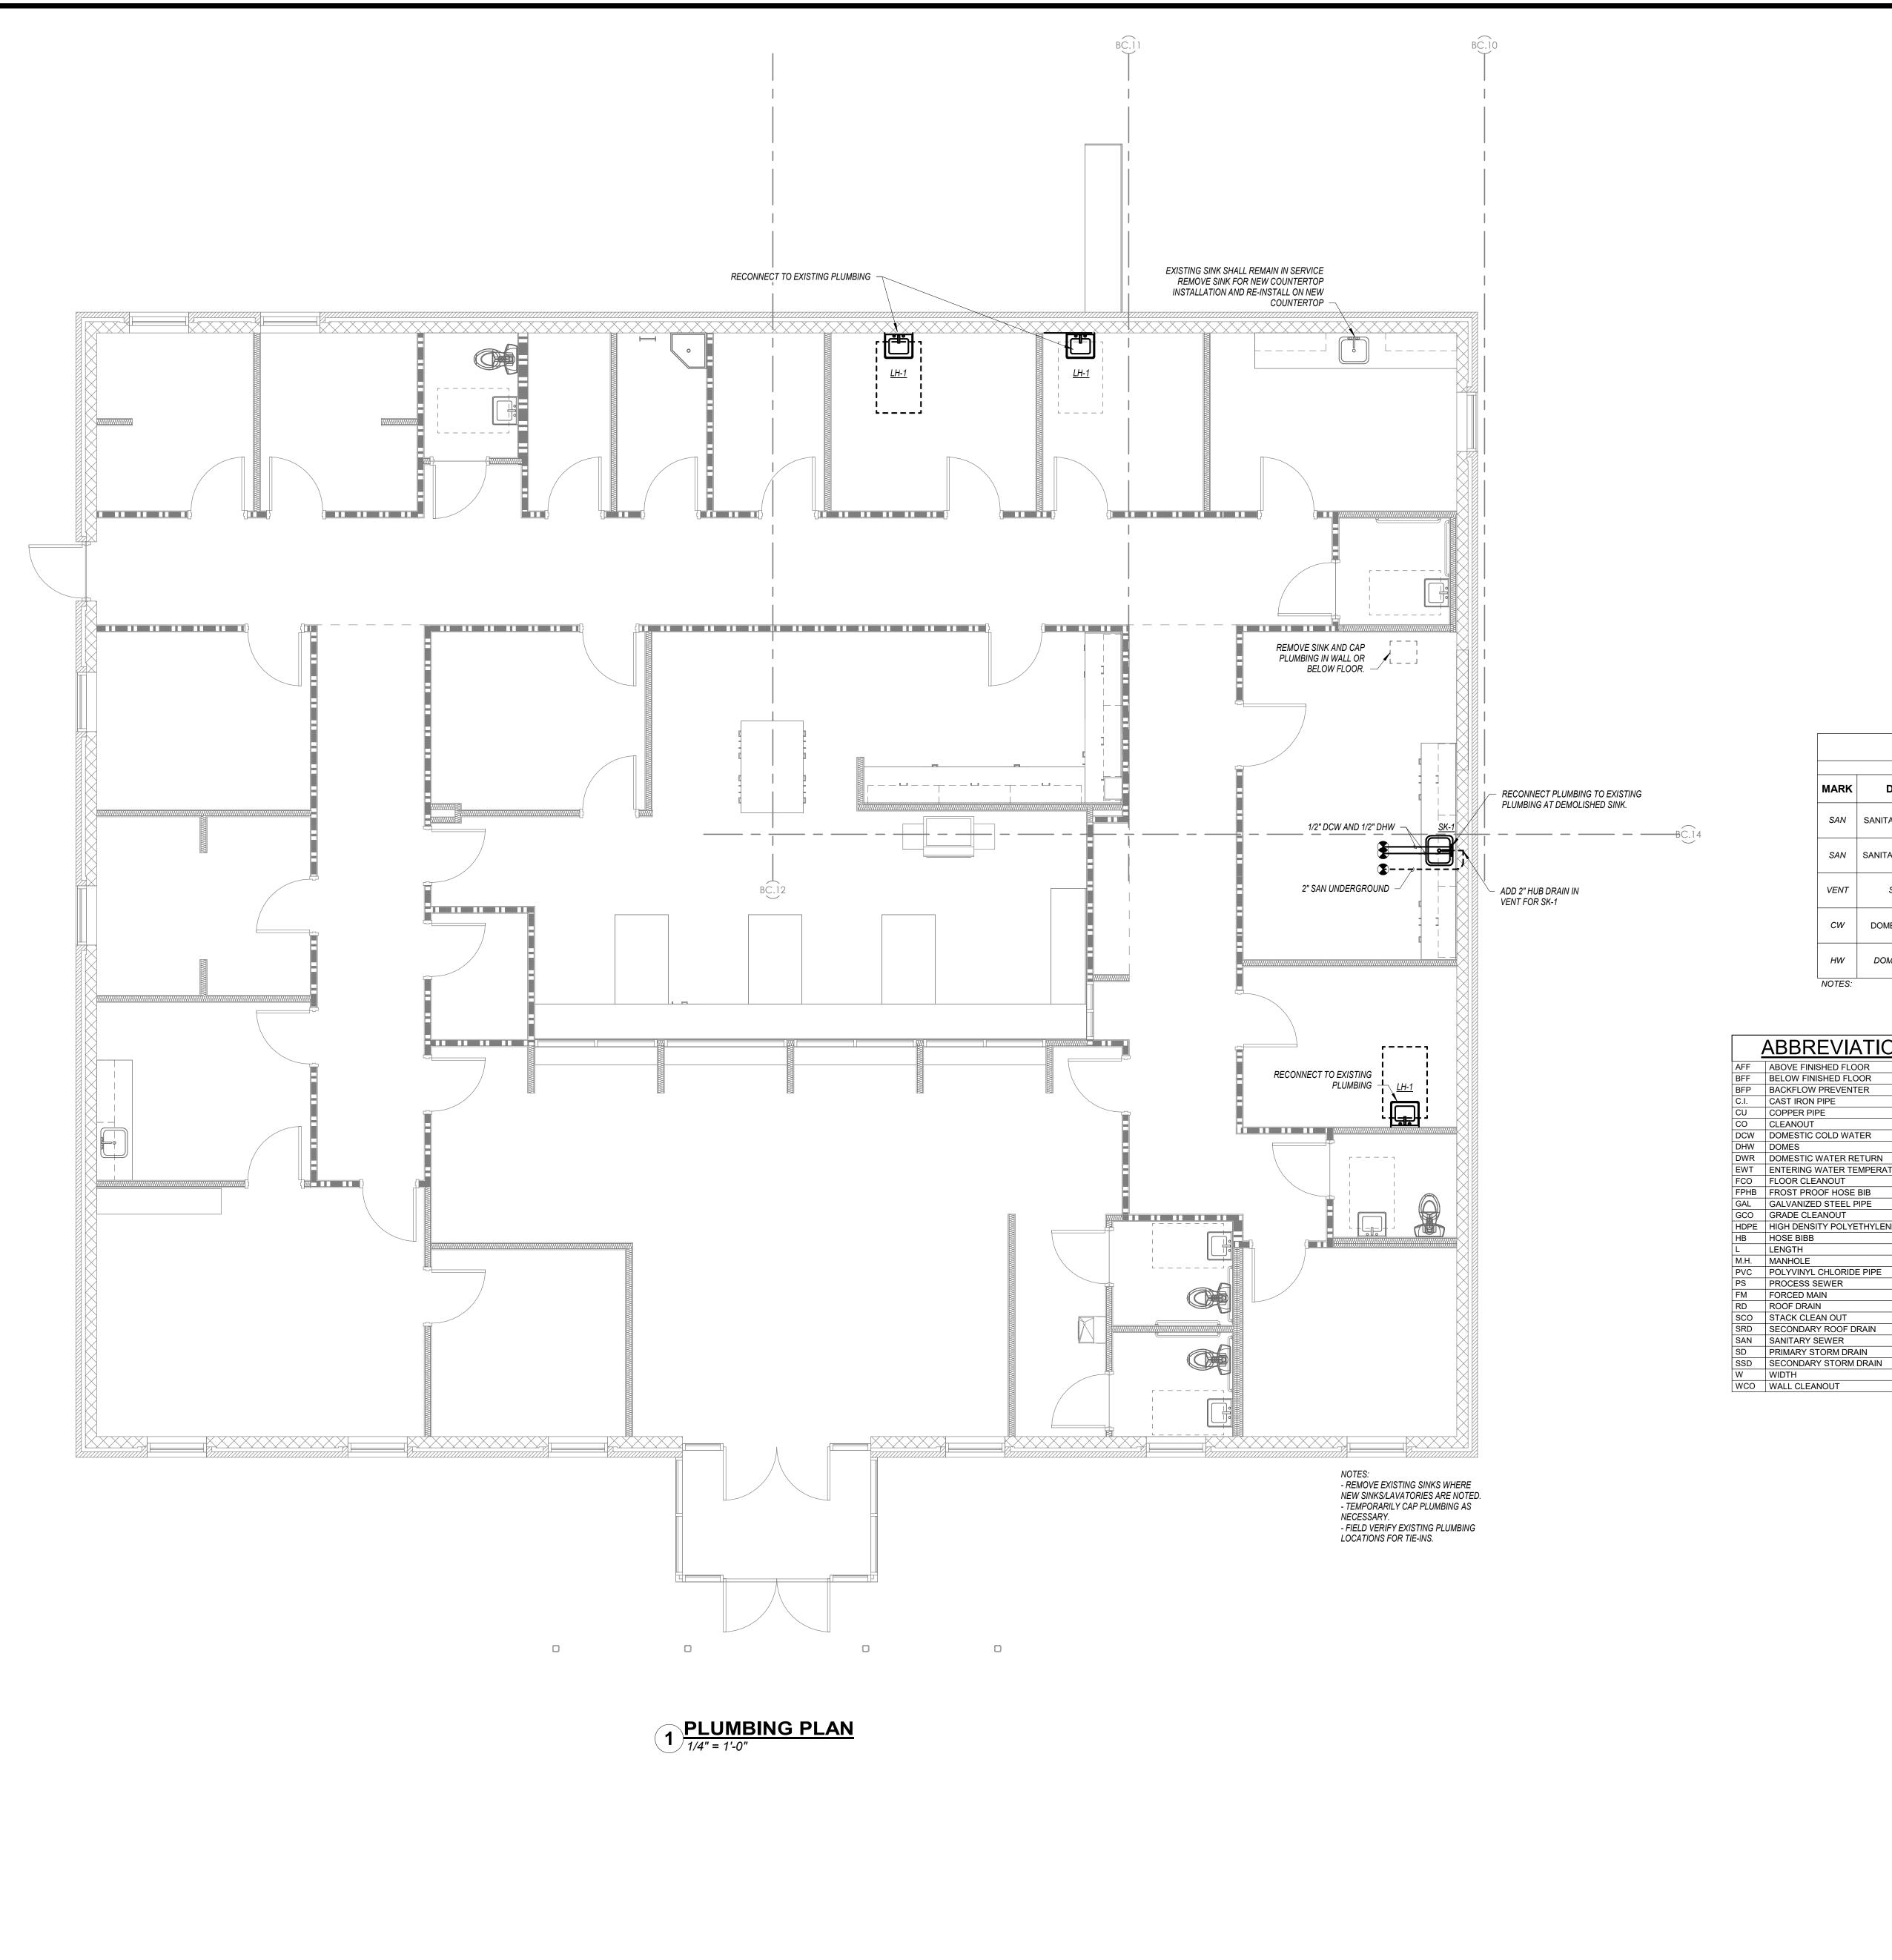22 BEFORE COMMENCING WORK ON SANITARY SEWER, CHECK INVERTS AND ENSURE THAT THESE CAN BE PROPERLY CONNECTED WITH SLOPE FOR DRAINAGE AND COVER TO AVOID FREEZING.

	PLUMBING PIPE SCHEDULES TYPICAL PIPING SCHEDULE								
MARK	DESCRIPTION	PIPE SIZE	PIPE MATERIAL	FITTING MATERIAL	INSULATION SPECS				
IVIAIN	DESCRIPTION	FIFE SIZE	FIFE WATERIAL	FITTING WATERIAL	THICKNESS	TYPE			
SAN	SANITARY (UNDERGROUND)	ALL	SCH 40 PVC	PVC DWV					
SAN	SANITARY (ABOVE GROUND)	ALL	SCH 40 PVC	PVC DWV					
VENT	CANITADY VENT	2 1/2" & LARGER	PVC	PVC					
VENT	SANITARY VENT	2" OR SMALLER	PVC	PVC					
CW	DOMESTIC COLD WATER	3" & LARGER	NA	NA					
CW	DOMESTIC COLD WATER	2 1/2" OR SMALLER	COPPER	COPPER	1/2"	FIBERGLASS W/ASJ OR CLOSED CELL			
1.047	DOMESTIC HOT WATER	1 1/2" & LARGER	COPPER	COPPER	1 1/2"	FIBERGLASS W/ASJ OR CLOSED CELL			
HW	DOMESTIC HOT WATER	1 1/4" OR SMALLER	COPPER	COPPER	1"	FIBERGLASS W/ASJ OR CLOSED CELL			

4	ABBREVIATIONS
AFF	ABOVE FINISHED FLOOR
BFF	BELOW FINISHED FLOOR
BFP	BACKFLOW PREVENTER
C.I.	CAST IRON PIPE
CU	COPPER PIPE
СО	CLEANOUT
DCW	DOMESTIC COLD WATER
DHW	DOMES
DWR	DOMESTIC WATER RETURN
EWT	ENTERING WATER TEMPERATURE
FCO	FLOOR CLEANOUT
FPHB	FROST PROOF HOSE BIB
GAL	GALVANIZED STEEL PIPE
GCO	GRADE CLEANOUT
HDPE	HIGH DENSITY POLYETHYLENE PIPE
НВ	HOSE BIBB
L	LENGTH
M.H.	MANHOLE
PVC	POLYVINYL CHLORIDE PIPE
PS	PROCESS SEWER
FM	FORCED MAIN
RD	ROOF DRAIN
SCO	STACK CLEAN OUT
SRD	SECONDARY ROOF DRAIN
SAN	SANITARY SEWER
SD	PRIMARY STORM DRAIN
SSD	SECONDARY STORM DRAIN
W	WIDTH
WCO	WALL CLEANOUT

	PLUMBING FIXTURE SCHEDULE							
MARK	TYPE	MODEL	CW	HW	DRAIN			
LH-1	LAVATORY, WALL HUNG, ADA HEIGHT	ZURN Z5344 20"X18" BOWL, ZURN Z7440-XL FAUCET, ADA INSULATION KIT, WATTS SERIES LFUSG-B MIXING VALVE	1/2"	1/2"	1-1/4"			
SK-1	STAINLESS STEEL SINGLE BOWL SINK	ELKAY LRQ1720 DROP-IN SINK, ZURN Z831B4-XL GOOSENECK FAUCET WITH WRISTBLADE HANDLES, WATTS SERIES LFUSG-B MIXING VALVE, PROVIDE WADE 5740 SOLIDS INTERCEPTOR	1/2"	1/2"	1-1/2"			

1. ALL MODEL NUMBERS CAN BE SUBSTITUTED WITH AN EQUIVILENT PRODUCT OF EQUAL QUALITY AND PERFORMANCE.

REVISIONS


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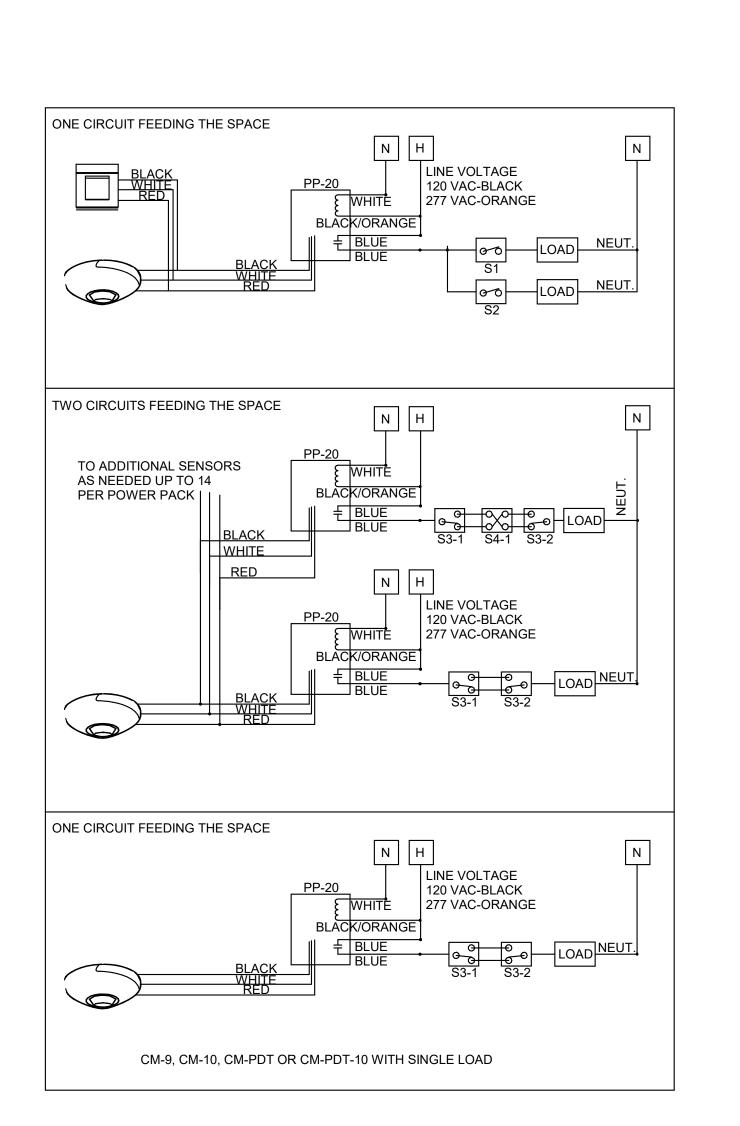
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P1-1

MOTION SENSOR LEGEND WALL SWITCH DECORATOR SENSOR - PASSIVE INFRARED (PIR) DW-200 WALL SWITCH DECORATOR SENSOR - DUAL TECHNOLOGY, DUAL RELAY STANDARD RANGE 360° SENSOR - CEILING MOUNT, LOW VOLTAGE, PASSIVE INFRARED (PIR) AND ULTRASONIC UNIVERSAL VOLTAGE POWER PACK: 120/277 VAC AUXILIARY RELAY PACK: 24 VDC MOTION SENSOR NOTES: #1- SENSOR PLACEMENT AND TYPES WERE PLACED WITH CURRENT PROJECT INFORMATION. ADDITIONAL SENSORS AND TYPES OF SENSORS MAY BE REQUIRED TO PROVIDE COMPLETE COVERAGE DEPENDING ON DRAWING CHANGES, EMS/BMS, FINAL PARTITION HEIGHT/PLACEMENT, FURNITURE PLACEMENT, EQUIPMENT HEIGHT/PLACEMENT AND SHELVING HEIGHT/PLACEMENT. #2- CEILING MOUNTED EXTENDED RANGE 360° SENSORS: FOR MAXIMUM DISTANCE ROTATE TO SENSOR CLOCKWISE SO THAT THE SCREW AXIS IS POSITIONED 7.5° OFF THE ENTRANCE AXIS. WHEN WALKING ACROSS A SENSOR'S BEAM, DETECTION WILL OCCUR AT APPROXIMATELY 28', WHEN WALKING DIRECTLY INTO A SENSOR'S BEAM, DETECTION WILL OCCUR AT APPROXIMATELY 24'. (REFER TO CUT SHEET FOR PICTORIAL OF ALIGNMENT) #3- SENSOR MASKING KITS MAY BE REQUIRED TO LIMIT COVERAGE DEPENDING ON SPACE REQUIREMENTS. #4- ALL MOTION SENSOR TIME DELAY SETTINGS SHALL NOT EXCEED 30 MINUTES.



TWO CIRCUIT OR TWO LOAD SENSOR CONTROL

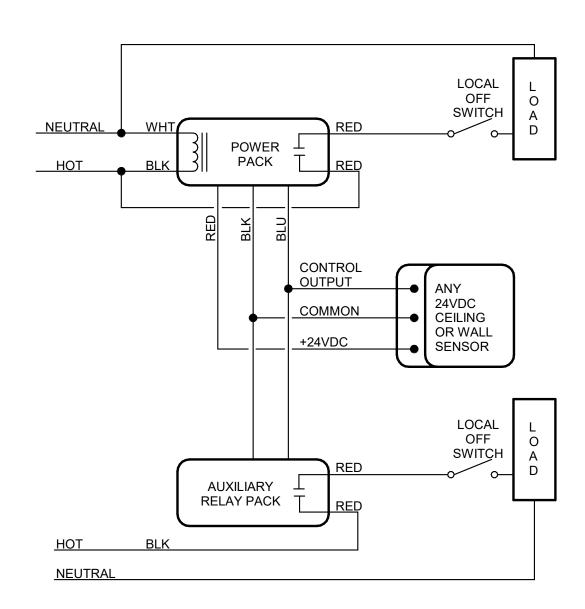

MOTION SENSOR LIGHTING **CONTROL WIRING DIAGRAMS**


BRANCH PANEL: ATS VOLTAGE AND PHASE: 120/208V, 3Ø, 4W MOUNTING: SURFACE ENCLOSURE: NEMA 1						S RATING: INS TYPE:	. •	ı					
									EXISTING	IA9	NELE	30A	RD
ĊΤ	TRIP	POLES	TYPE	FEED	Α		E	3	FEED	TYPE	POLES	TRIP	СКТ
	15 A	1	Е	LOBBY LIGHTS	0.3	2.5			COMPUTER RECEPTACLE	Е	1	20 A	2
3	20 A	1	Е	LOBBY/LAB/PHARMACY/NURSE LIGHTING			0.5	0.5	MED ROOM REFRIGERATOR	Е	1	20 A	4
5	20 A	1	Е	COMPUTER RECEPTACLE	0.4	0.5			FREEZER MED	E	1	20 A	6
,	20 A	1	Е	COMPUTER RECEPTACLE			0.7	0.5	FRIDGE MED	Е	1	20 A	8
)	20 A	1	Е	COPIER	0.2	0.0			FREEZER / MINI-SPLIT	Е	2	20 A	10
1	20 A	1	N	PHARMACY FREEZER			0.2	0.0	I INCLECTA IVIIINI-OF CIT	L		20 A	12
3	20 A	1	N	PHARMACY COUNTER RECEPTACLE	0.7	0.5			MED ROOM REFRIGERATOR	N	1	20 A	14
5	20 A	1	N	PHARMACY REFRIGERATOR			0.2	0.5	DEHUMIDIFIER	N	1	20 A	16
TOTAL KW / PHASE:				5.0) kW	3.1	kW						
TOTAL AMPS / PHASE:				4:	42 A		Α						
	DHASE	TOTAL		TOTAL KW:		8.1	kW						
	FIIAGE	IOIAL		TOTAL AMPS:		34	A						

EQUIPMENT".

- 1. ALL PANEL BOARDS TO BE "SQUARE D" OR AN APPROVED EQUAL.
- 2. ALL PANELBOARDS TO HAVE PLATED ELECTRIC GRADE ALUMINUM BUSES, GROUND BUSES, COVER MOUNTED PLASTIC ENGRAVED NAMEPLATES AND 'NEMA-1' ENCLOSURES. NAMEPLATES TO BE FASTENED TO COVER W/ SCREWS.
- 3. 120/208 VOLT BRANCH CIRCUIT BREAKERS TO HAVE A MINIMUM OF 10,000 AMPERES 'RMS' SYMMETRICAL INTERRUPTING CAPACITY.
- 4. BOTH SECTIONS OF ALL TWO SECTION PANELBOARDS TO BE THE SAME
- 5. PROVIDE HANDLE LOCK DEVICES FOR BRANCH CIRCUIT BREAKERS WHERE
- 6. PROVIDE ARC FLASH LABEL SHOWING REQUIRED "PERSONAL PROTECTION
- 7. PROVIDE GROUND FAULT CIRCUIT INTERRUPTER (GFCI), ARC FAULT CIRCUIT INTERRUPTER (AFCI) AND SHUNT TYPE BREAKERS WHERE NOTED IN THE SCHEDULE.
- 8. PANELBOARD SCHEDULES BREAKER TYPES ARE AS FOLLOWS:
- GFCI: GROUND FAULT CIRCUIT INTERRUPTER TYPE E: EXISTING BRANCH CIRCUIT BREAKER TO REMAIN PROVIDE NEW BRANCH CIRCUIT BREAKER TO MATCH
- 9. ALL BRANCH CIRCUIT BREAKERS SHOWN ARE EXISTING AND TO BE REUSED. VERIFY EXISTING CONDITIONS AND PROVIDE NEW BREAKERS IF

	SYMBOL SCHEDULE
SYMBOL	DESCRIPTION
/\)/	MOTOR CONNECTION (NUMBER IN CENTER INDICATES HORSEPOWER)
	DUPLEX 20A 125V RECEPTACLE. INSTALL @ 1'-6" A.F.F. IN FINISHED AREAS AND @ 4'-0" IN UNFINISHED AREAS.
	DUPLEX 20A 125V RECEPTACLE. INSTALL @ 44" A.F.F. FOR ABOVE COUNTER USE.
_	QUAD (2-DUPLEXES UNDER 1 COVER) 20A 125V RECEPTACLE. INSTALL @ 1'-6" A.F.F. IN FINISHED AREAS.
₩ ▷	EMPTY 2" X 4" J-BOX W 3/4" CONDUIT STUBBED INTO CEILING SPACE OR BAR JOIST AREA. INSTALL @ 1'-6" A.F.F.
• • • • • • • • • • • • • • • • • • •	TELEPHONE OUTLET W 3/4" CONDUIT STUBBED INTO CEILING SPACE. INSTALL @ 1'-6" A.F.F.
>	TELEPHONE/DATA OUTLET W 3/4" CONDUIT STUB INTO CEILING SPACE OR BAR JOIST AREA. INSTALL @ 1'-6" A.F.F.
\$	SPST 20A 125 OR 277V WALL SWITCH. INSTALL @ 4'-0" A.F.F.
\$2	DPST 20A 125 OR 277V WALL SWITCH. INSTALL @ 4'-0" A.F.F.
\$3	20A 125 OR 277V 3 WAY WALL SWITCH. INSTALL @ 4'-0" A.F.F.
\$4	20A 125 OR 277V 4WAY WALL SWITCH. INSTALL @ 4'-0" A.F.F.
<u> </u>	ENCLOSED 30A 3PST 600 VOLT SWITCH W/ LOCKOUT DEVICE
<u>\</u>	SAFETY DISCONNECT SWITCH. NF (NON-FUSED)
	THERMOSTAT. INSTALL @ 5'-0" A.F.F. INSTALL ABOVE WALL SWITCH WHERE POSSIBLE.
J OR J	JUNCTION OR PULLBOX. SIZE AS REQUIRED.
R	CARD READER.
	'L' PANEL. 120/208V. 3Ø, 4W LOW VOLTAGE LIGHTING AND POWER DISTRIBUTION PANEL.
	'H' PANEL 277/480V. 3Ø, 4W LIGHTING AND POWER DISTRIBUTION PANEL.
MP	UNIVERSAL VOLTAGE POWER PACK FOR MOTION SENSORS.
	RACEWAY WITH CONDUCTORS RUN CONCEALED IN FLOOR SLAB, IN WALLS OR IN EARTH.
<u>i</u>	RACEWAY WITH CONDUCTORS RUN EXPOSED. RUN PARALLEL AND AT RIGHT ANGLES TO BUILDING STRUCTURE.
<u>'</u> +	RACEWAY FOR TELEPHONE CABLES INSTALLED BY TELEPHONE COMPANY.
	BARE GROUND CONDUCTOR UNDERGROUND. SIZE AS NOTED ON PLANS.
<u> </u>	RACEWAY WITH CONDUCTORS RUN CONCEALED ABOVE CEILING, IN WALLS OR IN FURRED SPACES.
•	INSULATED GREEN GROUND CONDUCTOR. SAME SIZE AS PHASE WIRE UNLESS NOTED.
● -\	3/4"Ø x 10'-0" GROUND ROD WITH #3/0 JUMPER
A.F.F.	ABOVE FINISHED FLOOR
A.F.G.	ABOVE FINISHED GRADE
W.P.	WEATHER PROOF
D.T.	DUST TIGHT
E.F.	EXHAUST FAN
F.L.A.	FULL LOAD AMPS
H.A.C.	HEATING AND AIR CONDITIONING UNIT
R.T.U.	ROOF TOP HEATING AND AIR CONDITIONING UNIT
C.R.U.	COMPUTER ROOM HEATING AND AIR CONDITIONING UNIT
C.U.	CONDENSING UNIT
S.F.	SUPPLY FAN
F.A.C.P.	FIRE ALARM CONTROL PANEL
U.H.	UNIT HEATER (GAS FIRED UNLESS NOTED)
E.U.H.	ELECTRIC UNIT HEATER
T.C.	TIME CLOCK
S.C.	SECURITY CAMERA
W.H.	WATER HEATER
G.F.I.	GROUND FAULT INTERRUPT
F.D.	FLUORESCENT DIMMER
E.W.C.	ELECTRIC WATER COOLER
F.C.P.S	FIRE ALARM SYSTEM HORN/STROBE POWER SUPPLY
P.T.Z.	PAN TILT ZOOM DADIO EDEGLISMOV ANTENNA
R.F.	RADIO FREQUENCY ANTENNA
S.C.	SECURITY CAMERA
I.G.	INDEPENDENT GROUND

NOTES: THIS IS A STANDARD SYMBOLS SCHEDULE. ALL SYMBOLS SHOWN ON THIS SCHEDULE MAY NOT APPEAR IN THIS SET OF DRAWINGS.

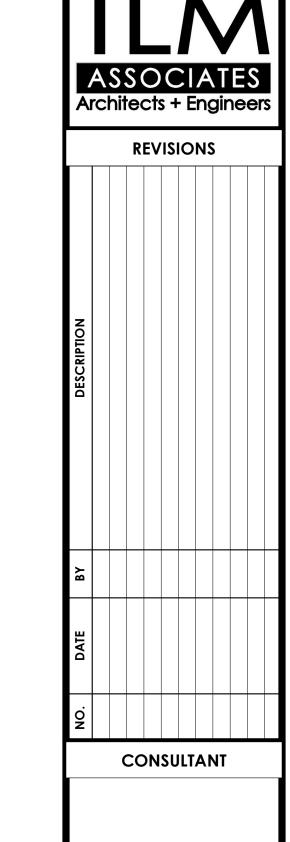



HICKMAN COUNT INTERIOR Hickr

SCHEDULE

JUNE 13, 2024

J-70878

EO.0



ELECTRICAL DEMOLITION PLAN

1/4" = 1'-0"

POWER NOTES:

#1- SEE SHEET E0-0 FOR SYMBOL SCHEDULE AND GENERAL POWER NOTES.

#2- ENSURE BRANCH CIRCUIT CONTINUITY AFTER DISCONNECTION AND REMOVAL OF RECEPTACLES AS SHOWN.

NOTES BY SYMBOL:

- DISCONNECT RECEPTACLES IN THIS WALL. INSTALL NEW RECEPTACLES IN NEW WALL AND RECONNECT TO SAME BRANCH CIRCUIT.
- DISCONNECT AND REMOVE RECEPTACLES IN THIS ROOM. REFER TO SHEET E3-1 FOR NEW RECEPTACLE LAYOUT.
- DISCONNECT AND REMOVE EXISTING RECEPTACLES AND DATA OUTLETS IN KNEE WALL TO BE REMOVED. INSTALL NEW RECEPTACLES IN SAME LOCALITY.
- DISCONNECT LIGHT FIXTURES IN THIS ROOM. REUSE OR TURN OVER TO THE OWNER AS REQUIRED ON SHEETS E2-1 OR E2-1A.

Architects + Engineers

REVISIONS

CONSULTANT




ELECTRICAL DEMOLITION PLAN

HICKMAN COUNTY HEALTH DEPARTMENT
INTERIOR RENOVATION
FOR
Hickman County
Centerville, Tennessee

JUNE 13, 2024

J-70878 **EO.1**

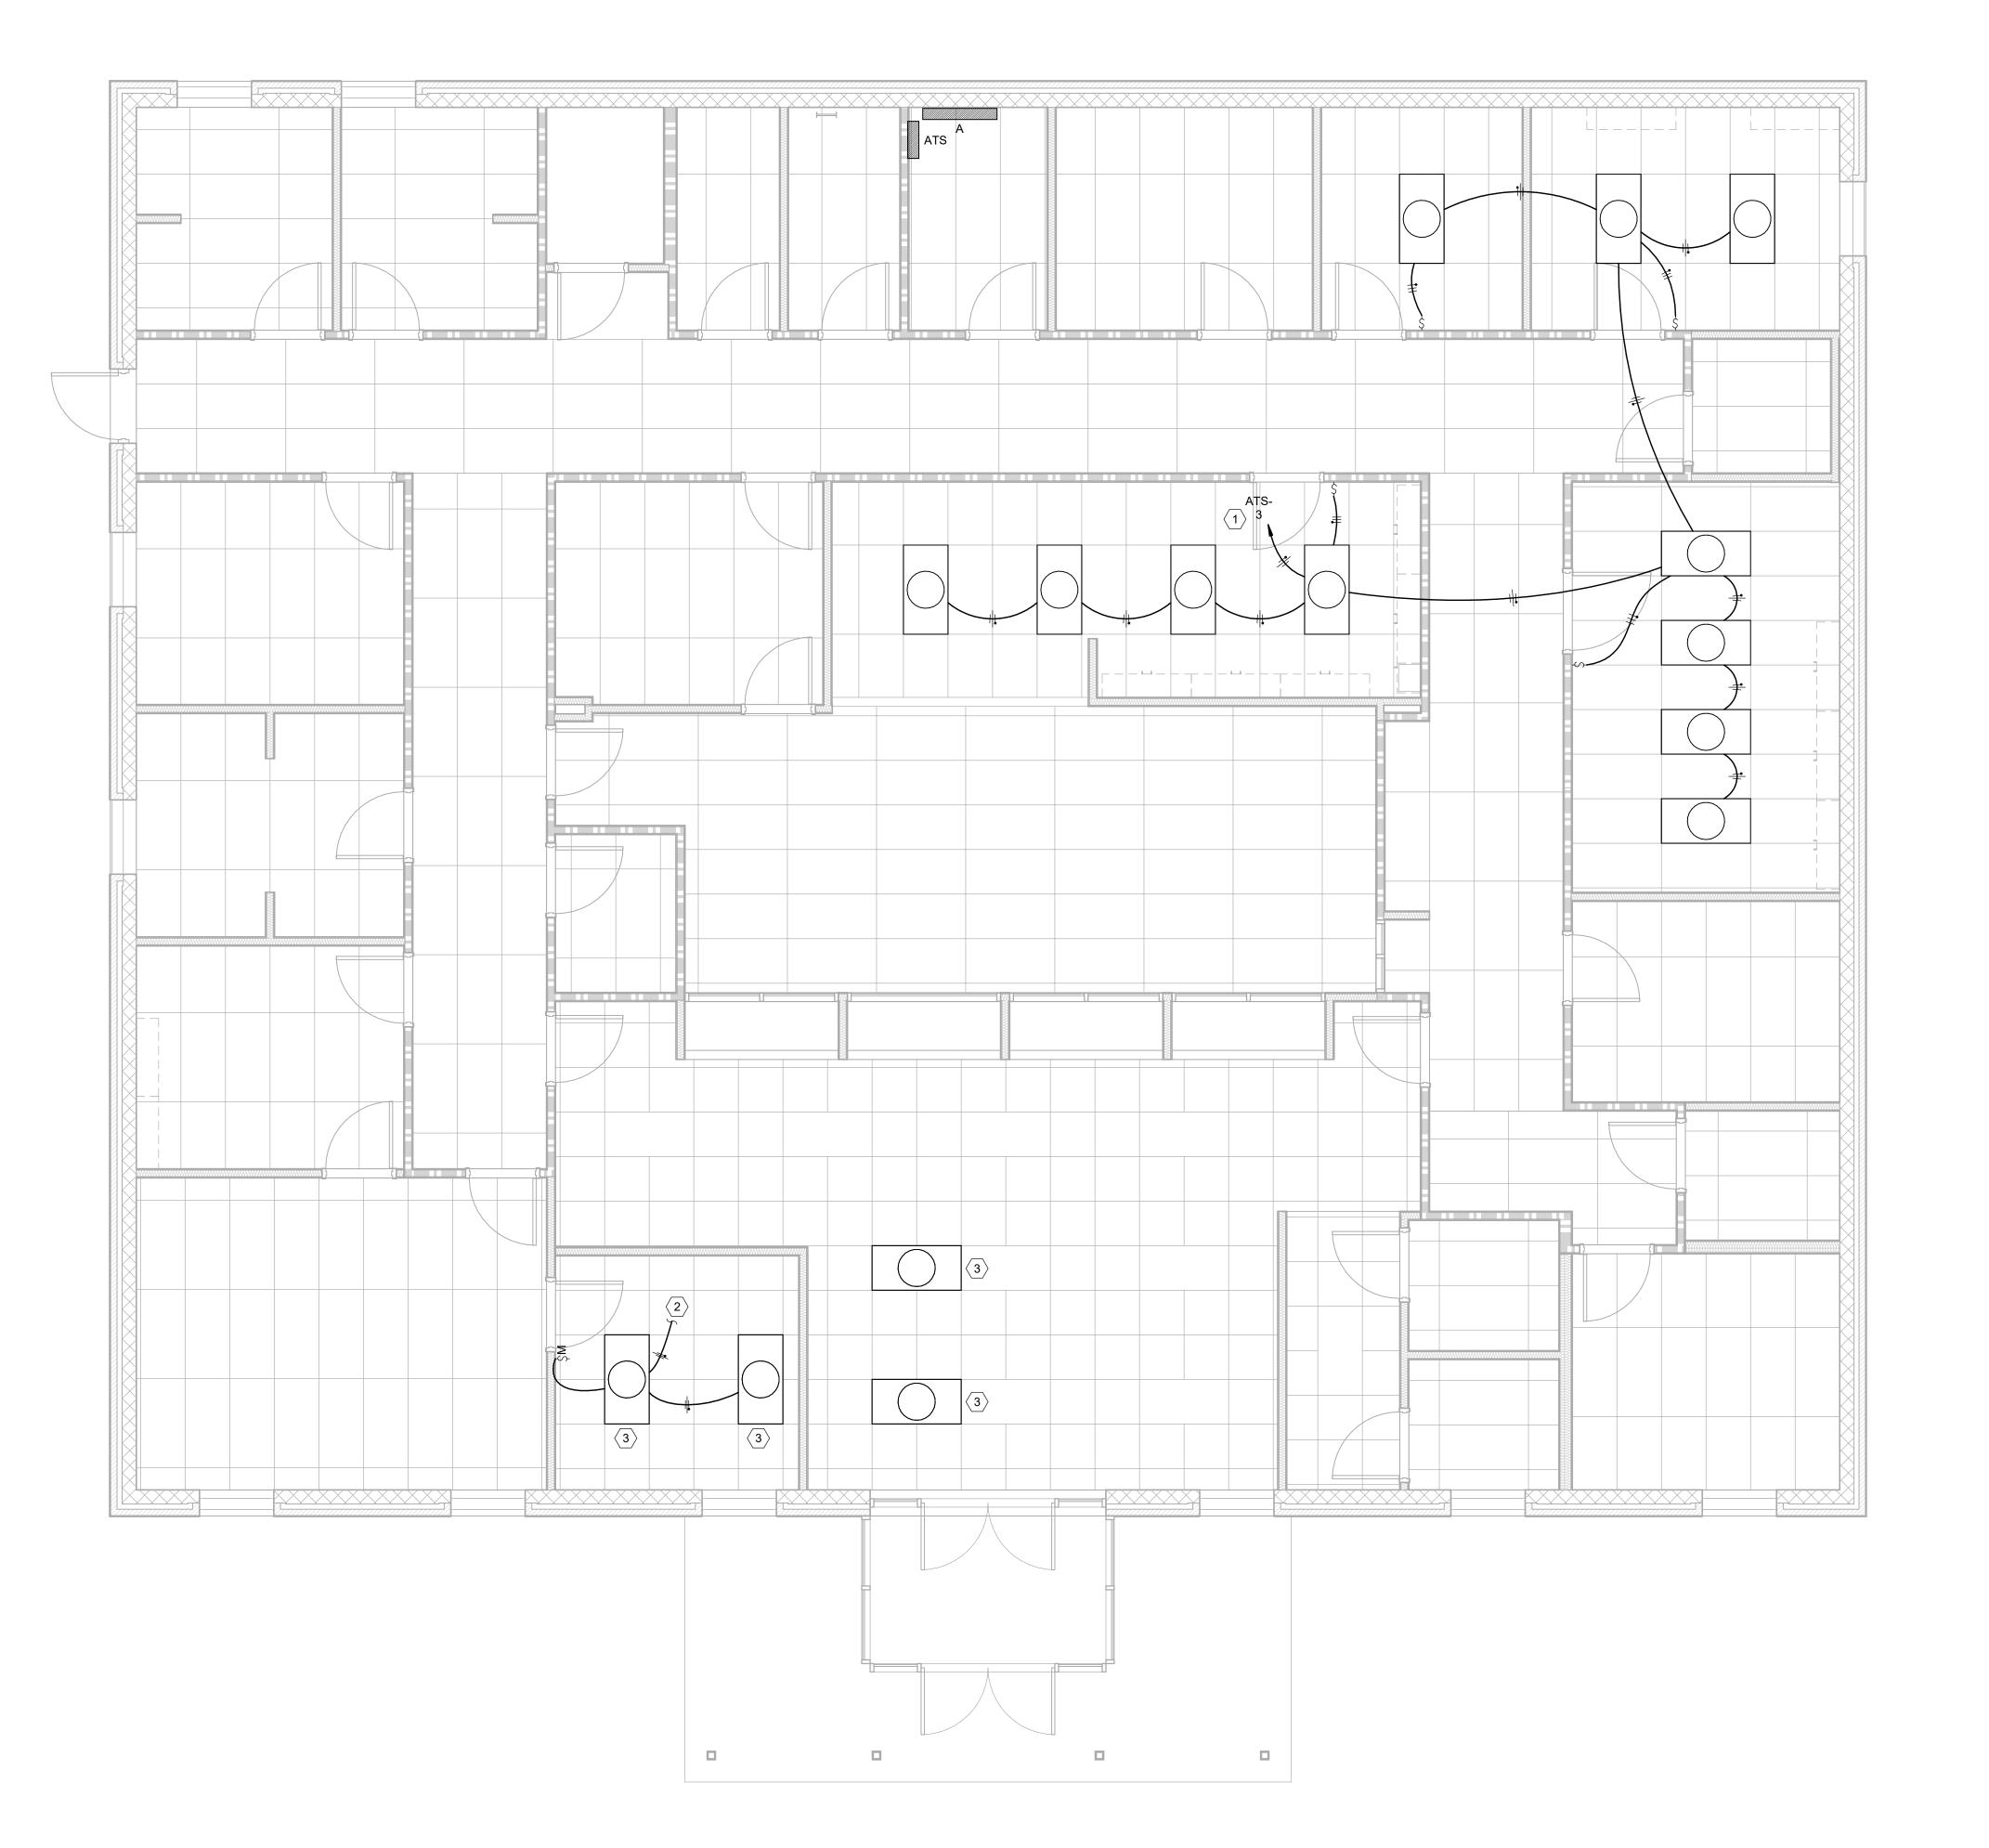

LIGHTING PLAN

1/4" = 1'-0"

	LUMINAIRE SCHEDULE								
TYPE MARK	LAMPS	VOLTAGE	MOUNTING	FINISH	SPECIFICATIONS				
Α	32W LED @ 4,100 LUMENS	120V	RECESSED CEILING	WHITE ENAMEL	2X4 LED RECESSED TROFFER FLAT PANEL FIXTURE WITH ELECTRONIC DRIVER. (DAYBRITE #2SBP3550L8CS-4-UNV-DIM OR EQUAL)				
В	19W LED @ 2,400 LUMENS	120V	SURFACE WALL @ 7'-0" A.F.F.	STANDARD	LED SURFACE MOUNT WRAPAROUND FIXTURE W/ DIFFUSE ACRYLIC LENS, AND ELECTRONIC DRIVER. (HE WILLIAMS #SLF-4-L26/840-HIA-DIM-UNV OR EQUAL)				
С	13W LED @ 1,500 LUMENS	120V	RECESSED CEILING	STANDARD	6" LED DOWNLIGHT WITH CLEAR ALZAK SEMI-DIFFUSE REFLECTOR. (HE WILLIAMS #6DR-TL-L15/840-DIM-UNV-OW-OF-CS-MWT-N OR EQUAL)				
D	13W LED @ 1,500 LUMENS	120V	RECESSED CEILING	STANDARD	6" LED DOWNLIGHT WITH CLEAR ALZAK SEMI-DIFFUSE REFLECTOR, WET LOCATION. (HE WILLIAMS #6DR-TL-L15/835-DIM-UNV-SW-SF-CS-WET/CC-N OR EQUAL)				
	LONG LIFE "LED" LAMPS	120V	SURFACE CEILING	WHITE	EMERGENCY FIXTURE W/ WHITE HOUSING AND EMERGENCY BATTERY BACK UP SYSTEM. (CHLORIDE #VE)				
∇	LED PAR LAMPS	120V	SURFACE WALL @ 8'-0" A.F.F.	WHITE	EXTERIOR EMERGENCY REMOTE HEAD FIXTURE. (CHLORIDE #VLL1R)				
4	LED PAR LAMPS	120V	SURFACE WALL	WHITE	EMERGENCY FIXTURE W/ WHITE HOUSING, H.O. LED LAMPS, EMERGENCY BATTERY BACK UP SYSTEM. (CHLORIDE # VLLU)				

LIGHTING NOTES:

#1- ELECTRICAL CONTRACTOR TO REUSE EXISTING LIGHT FIXTURES FOR WORK SHOWN THIS SHEET.

NOTES BY SYMBOL:

DISCONNECT FIXTURES FROM EXISTING LIGHTING BRANCH CIRCUITS AND CONNECT TO EXISTING LOBBY LIGHTING BRANCH CIRCUIT AS SHOWN.

RECONNECT EXISTING FIXTURES TO LOBBY LIGHTING BRANCH CIRCUIT AHEAD OF SWITCHED LEG.

3 SHIFT EXISTING FIXTURE IN CEILING GRID TO ACCOMODATE NEW PARTITION WALLS.

ASSOCIATES
Architects + Engineers

REVISIONS

BY DESCRIPTION

CONSULTANT

AGRICUITURE

AGRICUITURE

AGRICUITURE

ACTION

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ENGINEERS
com
lackson, Tennessee


ARCHITECTS + EN

HICKMAN COUNTY HEALTH DEPARTMENT
INTERIOR RENOVATION
FOR
Hickman County
Centerville, Tennessee

JUNE 13, 2024

J-70878

E2-1

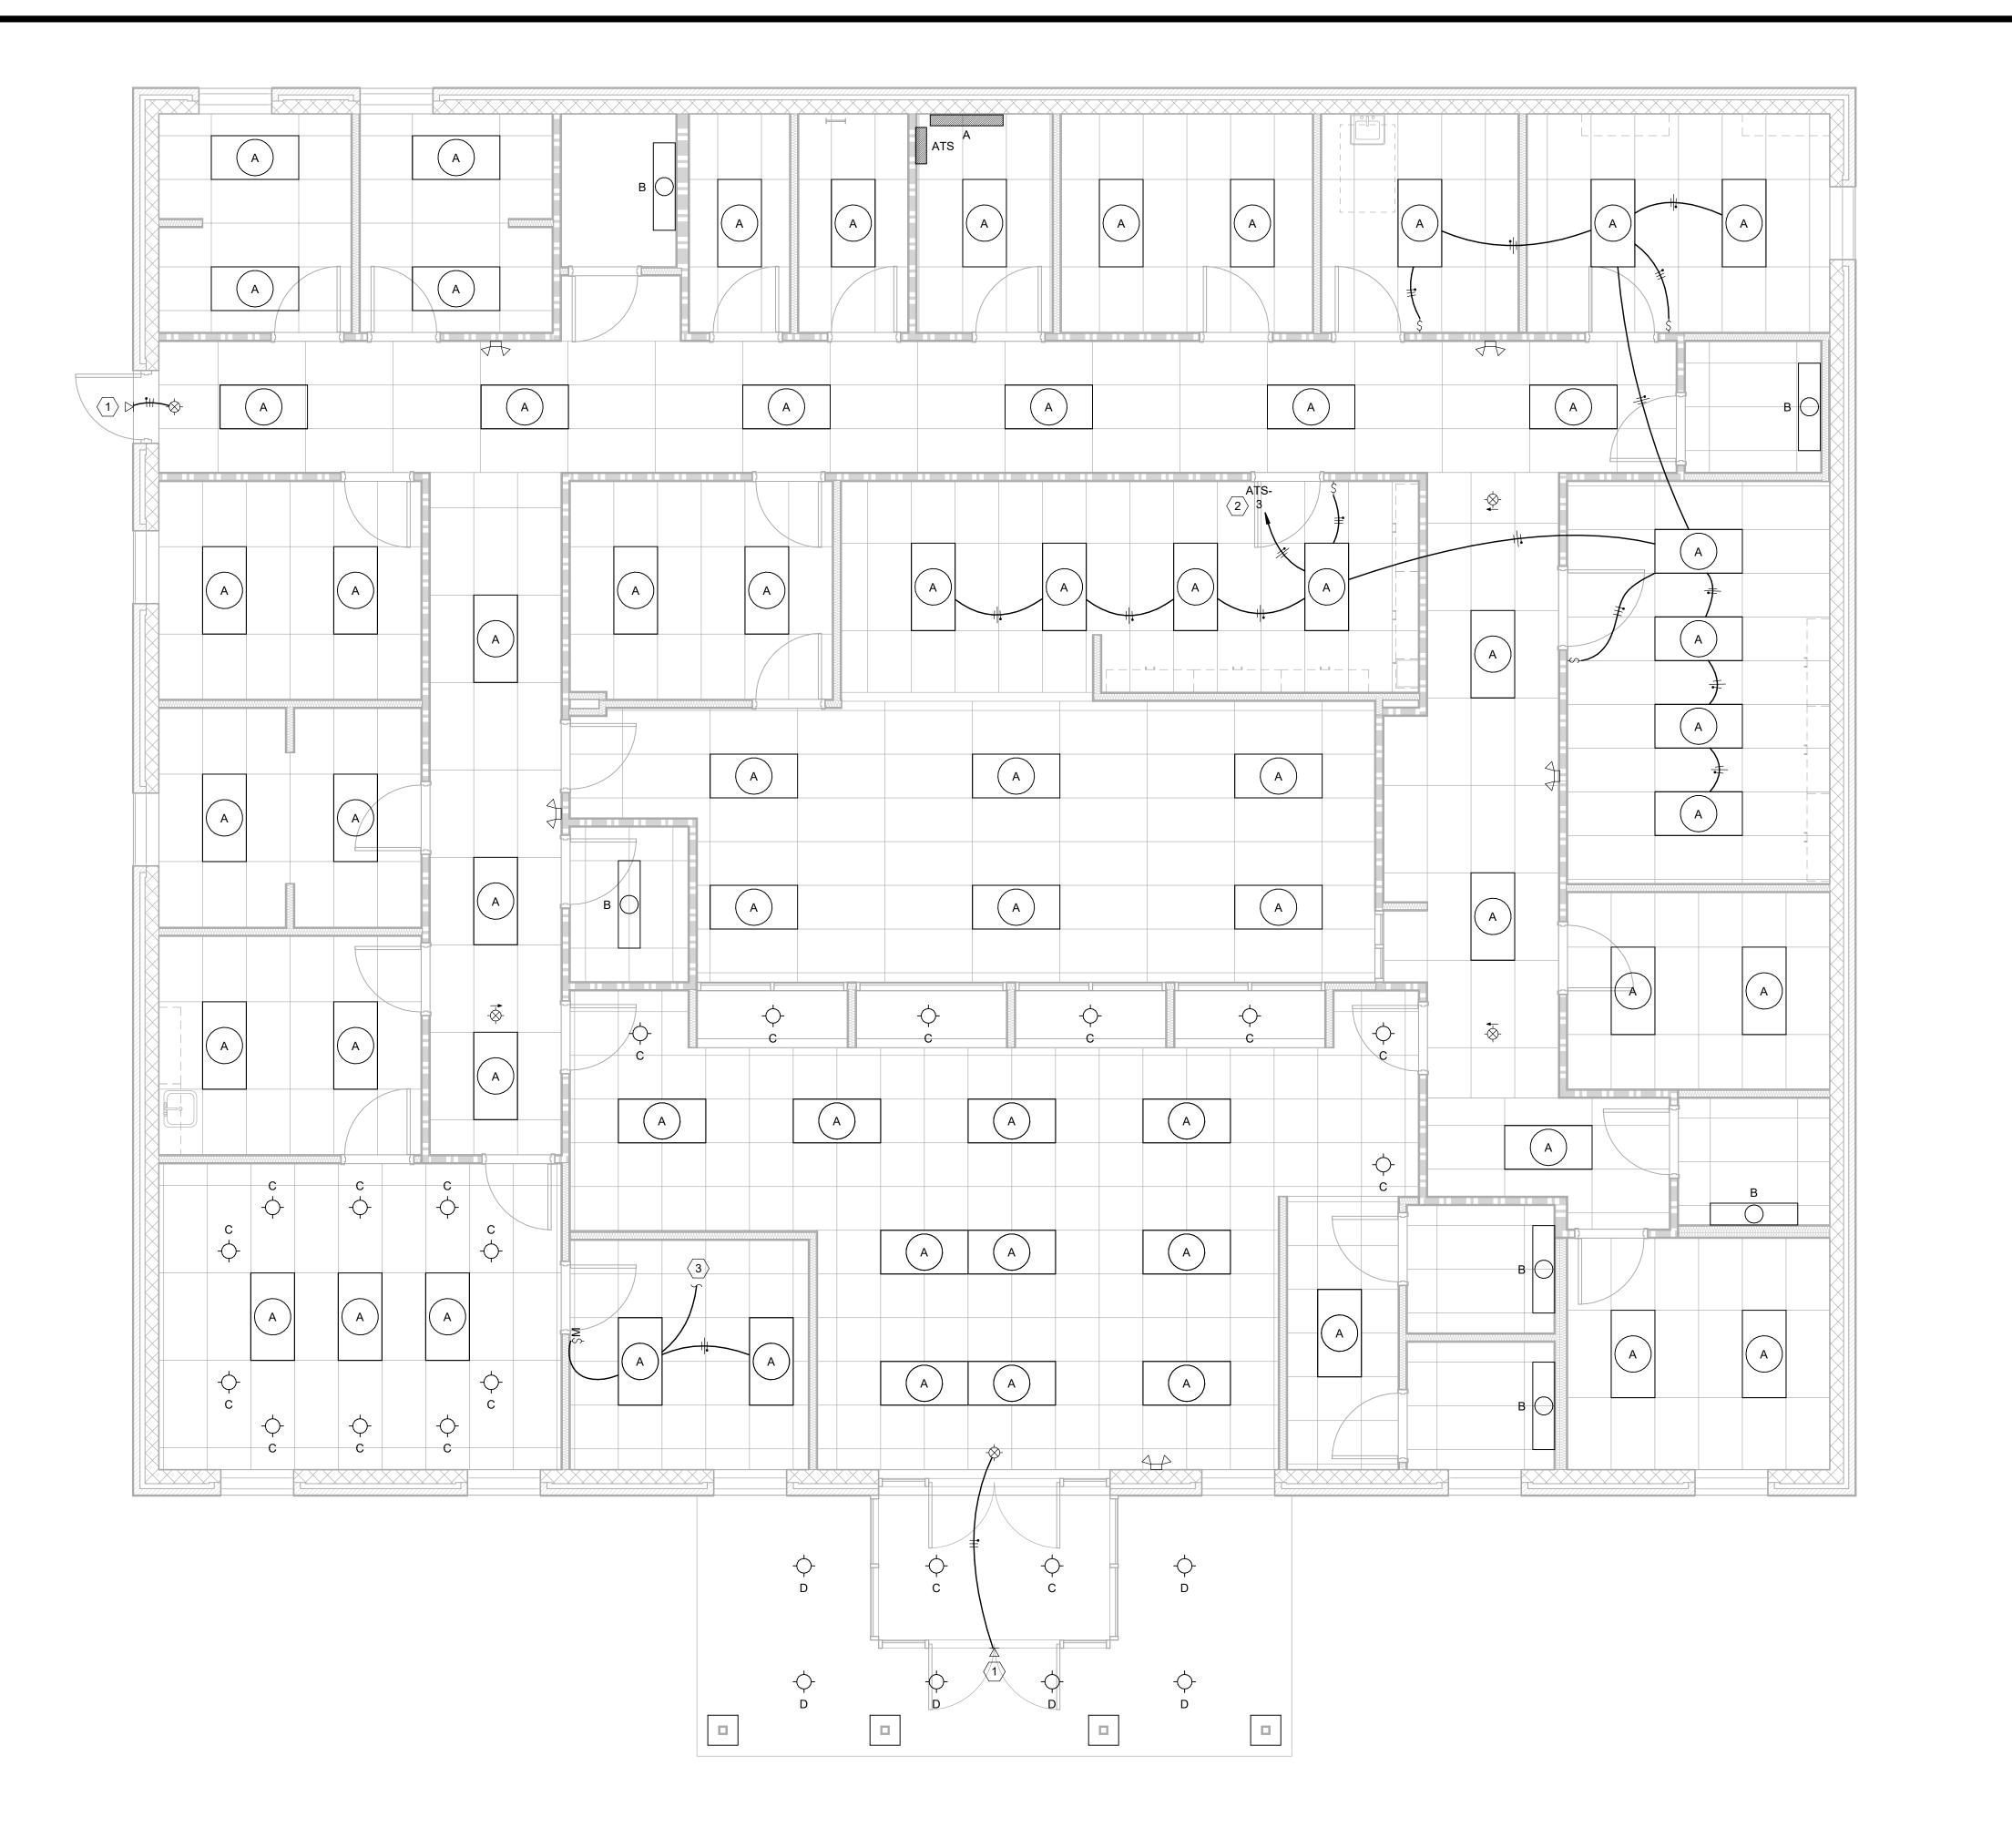

ALTERNATE LIGHTING PLAN 1/4" = 1'-0"

	LUMINAIRE SCHEDULE								
TYPE MARK	LAMPS	VOLTAGE	MOUNTING	FINISH	SPECIFICATIONS				
Α	32W LED @ 4,100 LUMENS	120V	RECESSED CEILING	WHITE ENAMEL	2X4 LED RECESSED TROFFER FLAT PANEL FIXTURE WITH ELECTRONIC DRIVER. (DAYBRITE #2SBP3550L8CS-4-UNV-DIM OR EQUAL)				
В	19W LED @ 2,400 LUMENS	120V	SURFACE WALL @ 7'-0" A.F.F.	STANDARD	LED SURFACE MOUNT WRAPAROUND FIXTURE W/ DIFFUSE ACRYLIC LENS, AND ELECTRONIC DRIVER. (HE WILLIAMS #SLF-4-L26/840-HIA-DIM-UNV OR EQUAL)				
С	13W LED @ 1,500 LUMENS	120V	RECESSED CEILING	STANDARD	6" LED DOWNLIGHT WITH CLEAR ALZAK SEMI-DIFFUSE REFLECTOR. (HE WILLIAMS #6DR-TL-L15/840-DIM-UNV-OW-OF-CS-MWT-N OR EQUAL)				
D	13W LED @ 1,500 LUMENS	120V	RECESSED CEILING	STANDARD	6" LED DOWNLIGHT WITH CLEAR ALZAK SEMI-DIFFUSE REFLECTOR, WET LOCATION. (HE WILLIAMS #6DR-TL-L15/835-DIM-UNV-SW-SF-CS-WET/CC-N OR EQUAL)				
	LONG LIFE "LED" LAMPS	120V	SURFACE CEILING	WHITE	EMERGENCY FIXTURE W/ WHITE HOUSING AND EMERGENCY BATTERY BACK UP SYSTEM. (CHLORIDE #VE)				
∇	LED PAR LAMPS	120V	SURFACE WALL @ 8'-0" A.F.F.	WHITE	EXTERIOR EMERGENCY REMOTE HEAD FIXTURE. (CHLORIDE #VLL1R)				
4	LED PAR LAMPS	120V	SURFACE WALL @ 8'-0" A.F.G.	WHITE	EMERGENCY FIXTURE W/ WHITE HOUSING, H.O. LED LAMPS, EMERGENCY BATTERY BACK UP SYSTEM. (CHLORIDE # VLLU)				

LIGHTING NOTES:

- #1- ELECTRICAL CONTRACTOR TO PROVIDE ALTERNATE PRICE FOR LIGHT FIXTURE CHANGE WORK SHOWN THIS SHEET.
- #2- ALL FIXTURES SHOWN THIS SHEET ARE TO BE CHANGED OUT FOR THE EXISTING FIXTURES ONE-FOR-ONE IN THE SAME LOCATIONS UNLESS NOTED OTHERWISE.
- #3- CONNECT ALL EMERGENCY EXIT SIGNS AHEAD OF AREA LIGHTING CONTROLS.

NOTES BY SYMBOL:

- PROVIDE NEW EXTERIOR EGRESS LIGHT FIXTURES AS SHOWN AND SCHEDULED.
- DISCONNECT FIXTURES FROM EXISTING LIGHTING BRANCH CIRCUITS AND CONNECT TO EXISTING LOBBY LIGHTING BRANCH CIRCUIT AS SHOWN.
- CONNECT NEW FIXTURES TO LOBBY LIGHTING BRANCH CIRCUIT AHEAD OF SWITCHED LEG.

ASSOCIATES
Architects + Engineers

REVISIONS

IO. DATE BY DESCRIPTION

CONSULTANT



ATES, INC.
ENGINEERS
com
dackson, Tennessee

ARCHITECTS + ENG

ALTERNATE LIGHTING PLAN
HICKMAN COUNTY HEALTH DEPARTMENT
FOR
FOR
Hickman County
Centerville, Tennessee

JUNE 13, 2024 J-70878

E2-1A



POWER PLAN
1/4" = 1'-0"

POWER NOTES:

- #1- SEE SHEET E0-0 FOR SYMBOL SCHEDULE AND GENERAL POWER NOTES.
- #2- HALF-TONE RECEPTACLES, EQUIPMENT AND BRANCH CIRCUITS TO REMAIN AND/OR BE RECONNECTED. VERIFY EXISTING CONDITIONS.

NOTES BY SYMBOL:

- RECONNECT THESE RECEPTACLES TO EXISTING BRANCH CIRCUIT AFTER WALL IS RELOCATED.
- RECONNECT THESE RECEPTACLES TO EXISTING BRANCH CIRCUIT. VERIFY EXISTING CONDITIONS AND BRANCH CIRCUIT CONNECTIONS.
- DISCONNECT EXISTING MINI-SPLIT WALL CASSETTE AND RECONNECT MINI-SPLIT IN NEW LOCATION. PROVIDE NEW CONDUCTORS AND RACEWAY BACK TO EXTERIOR CONDENSING UNIT AS REQUIRED.
- PROVIDE HARDWIRED CONNECTION TO DEHUMIDIFIER MOUNTED ABOVE ACCESIBLE CEILING SPACE.
- 5 EXISTING REFRIGERATOR/FREEZER DEDIDCATED RECEPTACLES TO REMAIN. VERIFY EACH RECEPTACLE HAS DEDICATED BRANCH CIRCUIT.
- PROVIDE NEW 20A 120V BRANCH CIRCUIT AND CONNECT TO SPARE 20A 1P BREAKER IN EXISTING PANEL 'A'.
- PROVIDE 120V CONNECTION TO NEW DOOR OPERATOR. COORDINATE EXACT CONNECTION LOCATION AND REQUIREMENTS WITH DOOR HARDWARE SUBMITTAL.
- PROVIDE A DOUBLE GANG SURFACE MOUNTED JUNCTION BOX FOR DOOR OPERATOR PUSH BUTTON AT 44" A.F.F. TO CENTER OF BOX. PROVIDE A 3/4" EMPTY EMT CONDUIT WITH PULL STRINGS FROM EACH JUNCTION BOX TO EACH DOOR OPERATOR. COORDINATE AND PROVIDE INSTALLATION OF PUSH BUTTON CONTROL CONDUCTORS WITH THE DOOR INSTALLER.

REVISIONS

Notice to the property of the prope

CONSULTANT



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HICKMAN COUNTY HEALTH DEPARI INTERIOR RENOVATION FOR Hickman County

JUNE 13, 2024 J-70878

E3-1