

FAYETTE COUNTY. TN FAYETTE COUNTY HEALTH DEPARTMENT




CONSTRUCTION DOCUMENTS JUNE 20, 2024

PROJECT NUMBER 23406

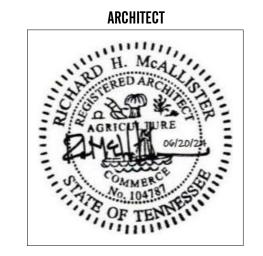


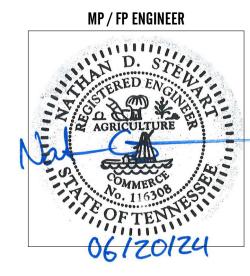

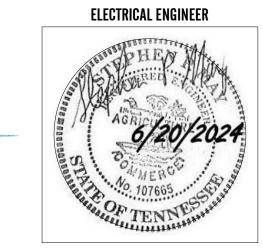

90 YUM YUM ROAD SOMERVILLE, TN 38068

A2H, INC. 009 DAVIES PLANTATION ROA LAKELAND, TN 38002 P. 901.372.0404

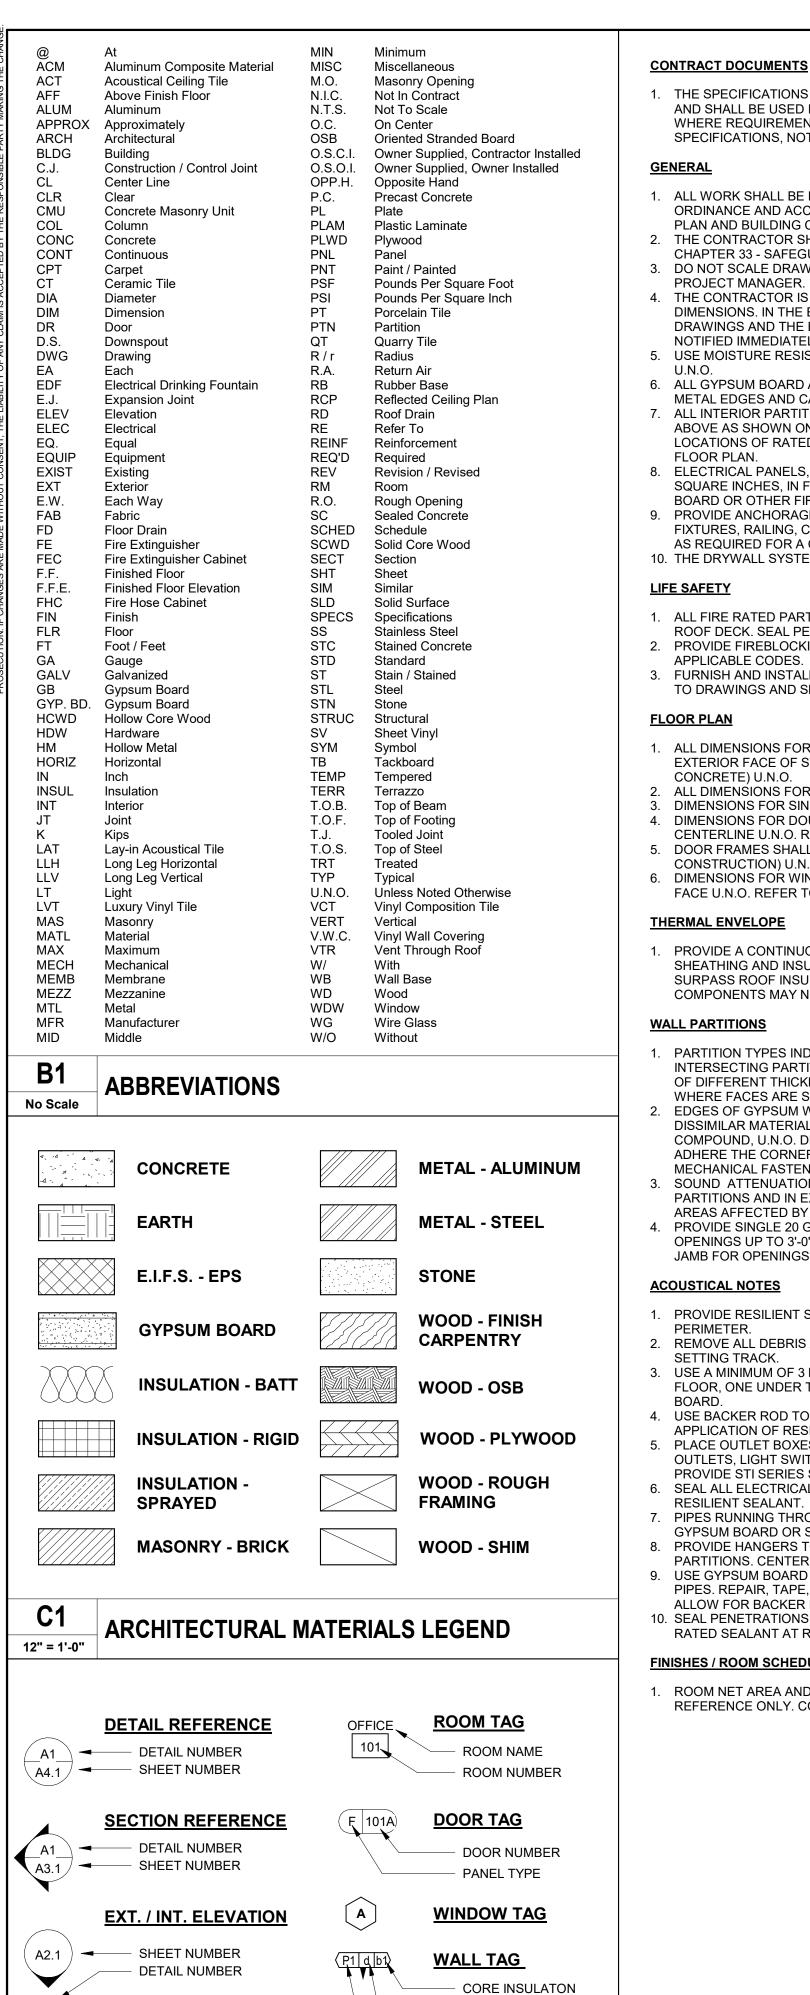

1. THE SPECIFICATIONS ARE AN INTEGRAL PART OF THE CONTRACT DOCUMENTS AND SHALL BE USED IN CONJUNCTION WITH THE DRAWINGS. IN CASES, IF ANY, WHERE REQUIREMENTS INDICATED ON THE DRAWINGS DIFFER FROM THE SPECIFICATIONS, NOTIFY A2H PROJECT MANAGER.

GENERAL

- ALL WORK SHALL BE DONE IN ACCORDANCE WITH ALL APPLICABLE CODES, ORDINANCE AND ACCEPTED INDUSTRY STANDARDS. REFER TO LIFE SAFETY
- PLAN AND BUILDING CODE DATA FOR MORE INFORMATION. 2. THE CONTRACTOR SHALL ABIDE BY THE INTERNATIONAL BUILDING CODE CHAPTER 33 - SAFEGUARDS DURING CONSTRUCTION. 3. DO NOT SCALE DRAWINGS. IF DIMENSIONS ARE IN QUESTION, NOTIFY THE A2H
- PROJECT MANAGER. 4. THE CONTRACTOR IS RESPONSIBLE FOR VERIFYING ALL FIELD CONDITIONS AND DIMENSIONS. IN THE EVENT OF ENCOUNTERING ANY CONFLICT BETWEEN THE DRAWINGS AND THE EXISTING CONDITIONS, A2H PROJECT MANAGER SHALL BE NOTIFIED IMMEDIATELY.
- 5. USE MOISTURE RESISTANT BOARD AT ALL WALLS WITH PLUMBING FIXTURES U.N.O.
- 6. ALL GYPSUM BOARD ABUTTING OTHER MATERIALS IS TO BE FINISHED WITH METAL EDGES AND CAULKED OR FIRE STOPPED AS REQUIRED. 7. ALL INTERIOR PARTITIONS SHALL BE CONTINUOUS FROM FLOOR TO STRUCTURE
- ABOVE AS SHOWN ON WALL SECTIONS AND DETAILS U.N.O. THE EXTENT AND LOCATIONS OF RATED PARTITIONS AND SMOKE PARTITIONS ARE SHOWN ON THE FLOOR PLAN. 8. ELECTRICAL PANELS, FIRE HOSE CABINETS, AND RECESSED OBJECTS OVER 16
- BOARD OR OTHER FIRESTOPPING MATERIAL TO MAINTAIN THE WALL RATING. 9. PROVIDE ANCHORAGE, BLOCKING, BACKING AND FRAMING FOR EQUIPMENT, FIXTURES, RAILING, CASEWORK, TOILET PARTITIONS, TOILET ACCESSORIES, ETC.

SQUARE INCHES, IN FIRE RATED WALLS, ARE TO BE WRAPPED IN GYPSUM

AS REQUIRED FOR A COMPLETE INSTALLATION. 10. THE DRYWALL SYSTEM IS BASED ON DETAILS OF THE U.S. GYPSUM COMPANY.

1. ALL FIRE RATED PARTITIONS SHALL EXTEND TO UNDERSIDE OF FLOOR DECK /

- ROOF DECK. SEAL PERIMETER AND PENETRATIONS PER CODES. 2. PROVIDE FIREBLOCKING AND DRAFTSTOPPING IN CONCEALED SPACES PER
- 3. FURNISH AND INSTALL MANUAL FIRE EXTINGUISHERS PER LOCAL CODES. REFER TO DRAWINGS AND SPECIFICATIONS.

FLOOR PLAN

- 1. ALL DIMENSIONS FOR EXTERIOR WALLS ARE TO EDGE OF SLAB AND/OR EXTERIOR FACE OF STUD OR EXTERIOR FACE OF FINISH VENEER (MASONRY OR
- 2. ALL DIMENSIONS FOR INTERIOR PARTITIONS ARE TO FINISH FACE OF WALL U.N.O. 3. DIMENSIONS FOR SINGLE DOORS ARE TO OUTSIDE FACE OF FRAME U.N.O.
- 4. DIMENSIONS FOR DOUBLE DOORS ARE TO OUTSIDE FACE OF FRAME OR DOOR CENTERLINE U.N.O. REFER TO DOOR SCHEDULE.
- 5. DOOR FRAMES SHALL BE LOCATED 4" FROM CORNERS (8" FOR C.M.U.
- 6. DIMENSIONS FOR WINDOW ARE TO CENTERLINE OF UNIT OR TO ROUGH OPENING FACE U.N.O. REFER TO WINDOW SCHEDULE.

THERMAL ENVELOPE

 PROVIDE A CONTINUOUS THERMAL ENVELOPE INCLUDING WALL STRUCTURE, SHEATHING AND INSULATION. WALL ASSEMBLY INSULATION TO OVERLAP AND/OR SURPASS ROOF INSULATION. INSULATION AND RELATED THERMAL BARRIER COMPONENTS MAY NOT BE SHOWN IN DRAWINGS FOR CLARITY.

WALL PARTITIONS

- 1. PARTITION TYPES INDICATED ARE CONTINUOUS TO A CORNER OR AN INTERSECTING PARTITION, UNLESS INDICATED OTHERWISE. WHERE PARTITIONS OF DIFFERENT THICKNESSES MEET, MAINTAIN A FLUSH SURFACE ON THE SIDE WHERE FACES ARE STRAIGHT AND CONTINUOUS. UNLESS NOTED OTHERWISE.
- EDGES OF GYPSUM WALL BOARD LEFT EXPOSED TO VIEW OR ABUTTING DISSIMILAR MATERIALS ARE TO BE FINISHED WITH METAL BEAD TRIM AND JOINT COMPOUND, U.N.O. DRYWALL ADHESIVES WILL NOT BE ALLOWED TO BE USED TO ADHERE THE CORNER BEADS, UNLESS USED IN CONJUNCTION WITH PERMANENT
- 3. SOUND ATTENUATION BATTS (SAB) ARE TO BE PLACED IN ALL NEW PARTITIONS AND IN EXISTING PARTITIONS ADJACENT TO RENOVATED AREAS OR AREAS AFFECTED BY RENOVATION.
- 4. PROVIDE SINGLE 20 GAUGE 3 5/8" METAL STUD AT EACH DOOR JAMB FOR OPENINGS UP TO 3'-0" WIDE. PROVIDE DOUBLE 20 GAUGE STUDS AT EACH DOOR JAMB FOR OPENINGS OVER 3'-0" WIDE.

ACOUSTICAL NOTES

- 1. PROVIDE RESILIENT SEALANT BOTH SIDES OF PARTITIONS AROUND THE PERIMETER.
 - 2. REMOVE ALL DEBRIS AT THE FLOOR AND BROOM SWEEP CLEAN BEFORE SETTING TRACK.
 - 3. USE A MINIMUM OF 3 BEADS OF RESILIENT SEALANT (1/4" THICK MIN.) AT THE FLOOR, ONE UNDER THE TRACK, AND ONE BEAD BOTH SIDES AT GYPSUM
 - 4. USE BACKER ROD TO CLOSE OFF OPENINGS GREATER THAN 1/4" PRIOR TO APPLICATION OF RESILIENT SEALANT.
 - PLACE OUTLET BOXES IN SEPARATE STUD SPACES. THIS INCLUDES ELECTRICAL OUTLETS, LIGHT SWITCHES, AUDIO, DATA, AND TELEPHONE OUTLET BOXES.
 - PROVIDE STI SERIES SSP PUTTY PADS OR EQUAL BEHIND ALL BOXES. 6. SEAL ALL ELECTRICAL BOXES TO THEIR GYPSUM BOARD CUT-OUT WITH RESILIENT SEALANT.
 - 7. PIPES RUNNING THROUGH WALLS SHALL NOT MAKE RIGID CONTACT WITH GYPSUM BOARD OR STUDS.
 - 8. PROVIDE HANGERS TO SUPPORT PIPE. DO NOT CARRY PIPE WEIGHT ON PARTITIONS. CENTER PIPE IN PARTITION OPENING.
 - 9. USE GYPSUM BOARD FILLER PIECES TO CLOSE OFF LARGE OPENINGS AROUND PIPES. REPAIR, TAPE, AND MUD WALL AND PROVIDE TIGHT FIT AROUND PIPE TO ALLOW FOR BACKER ROD AND RESILIENT SEALANT
 - 10. SEAL PENETRATIONS WITH RESILIENT SEALANT TO CLOSE GAPS. USE FIRE RATED SEALANT AT RATED PARTITIONS.

FINISHES / ROOM SCHEDULE

GENERAL NOTES

No Scale

HEIGHT DESIGNATION

- WALL TYPE

SYMBOLS LEGEND

1/4" = 1'-0"

ROOM NET AREA AND PERIMETER LENGTH SHOWN IN SCHEDULE(S) IS FOR REFERENCE ONLY. CONTRACTOR IS RESPONSIBLE TO VERIFY QUANTITIES.

EXISTING CONSTRUCTION

- 1. INFORMATION ON EXISTING CONSTRUCTION IS BASED ON RECORD DRAWINGS PROVIDED TO A2H, INC. BY THE OWNER, A2H, INC. IS NOT RESPONSIBLE FOR VERIFYING ALL INFORMATION IN SUCH RECORD DOCUMENTS. A2H. INC. MAKES NO CLAIM TO THE COMPLETENESS, ACCURACY, OR USE OF DRAWING
- INFORMATION RELATING TO EXISTING CONDITIONS. 2. THE CONTRACTOR IS RESPONSIBLE FOR EXAMINING EXISTING CONDITIONS AS NEEDED TO VERIFY INFORMATION RELATING TO EXISTING CONSTRUCTION ELEMENTS DEPICTED ON THESE DRAWINGS.

No Scale

DISCLAIMER NOTES



C3

NTS

VICINITY MAP



NORTH

PROJECT LOCATION



NTS

LOCATION MAP / VIEW



NUMBER SHEET NAME

COVER SHEET PROJECT DATA AND NOTES

LIFE SAFETY PLAN

ARCHITECTURAL

NUMBER SHEET NAME

FLOOR PLAN - EXISTING / DEMOLITION

FLOOR PLAN - NOTED FLOOR PLAN - DIMENSIIONED

FINISH DETAILS

FINISH PLAN AND SCHEDULES **INTERIOR ELEVATIONS**

INTERIOR ELEVATIONS INTERIOR SECTIONS AND DETAILS

INTERIOR SECTIONS AND DETAILS

REFLECTED CEILING PLAN

MECHANICAL

NUMBER SHEET NAME

HVAC FLOOR PLAN - DEMOLITION

HVAC FLOOR PLAN

HVAC SCHEDULES & DETAILS

PLUMBING

NUMBER SHEET NAME

P1.0 PLUMBING FLOOR PLAN - DEMOLITION

PLUMBING FLOOR PLAN

ELECTRICAL

NUMBER SHEET NAME

E0.0 ELECTRICAL LEGEND AND NOTES

ELECTRICAL SPECIFICATIONS LIGHTING - DEMOLITION FLOOR PLAN

LIGHTING - FIRST FLOOR PLAN

POWER - DEMOLITION FLOOR PLAN POWER - FIRST FLOOR PLAN

AUXILIARY - DEMOLITION FLOOR PLAN

AUXILIARY - FIRST FLOOR PLAN **ELECTRICAL DETAILS**

FAYETTE COUNTY,

A2H. INC.

3009 DAVIES PLANTATION ROAD

LAKELAND, TN 38002

P. 901.372.0404

WWW.A2H.COM

FAYETTE COUNTY HEALTH DEPARTMENT

90 YUM YUM ROAD SOMERVILLE, TN 38068

> CONSTRUCTION **DOCUMENTS**


> > REVISIONS

DATE JUNE 20, 2024

CHECKED PROJECT DATA AND

NOTES

SHEET INDEX

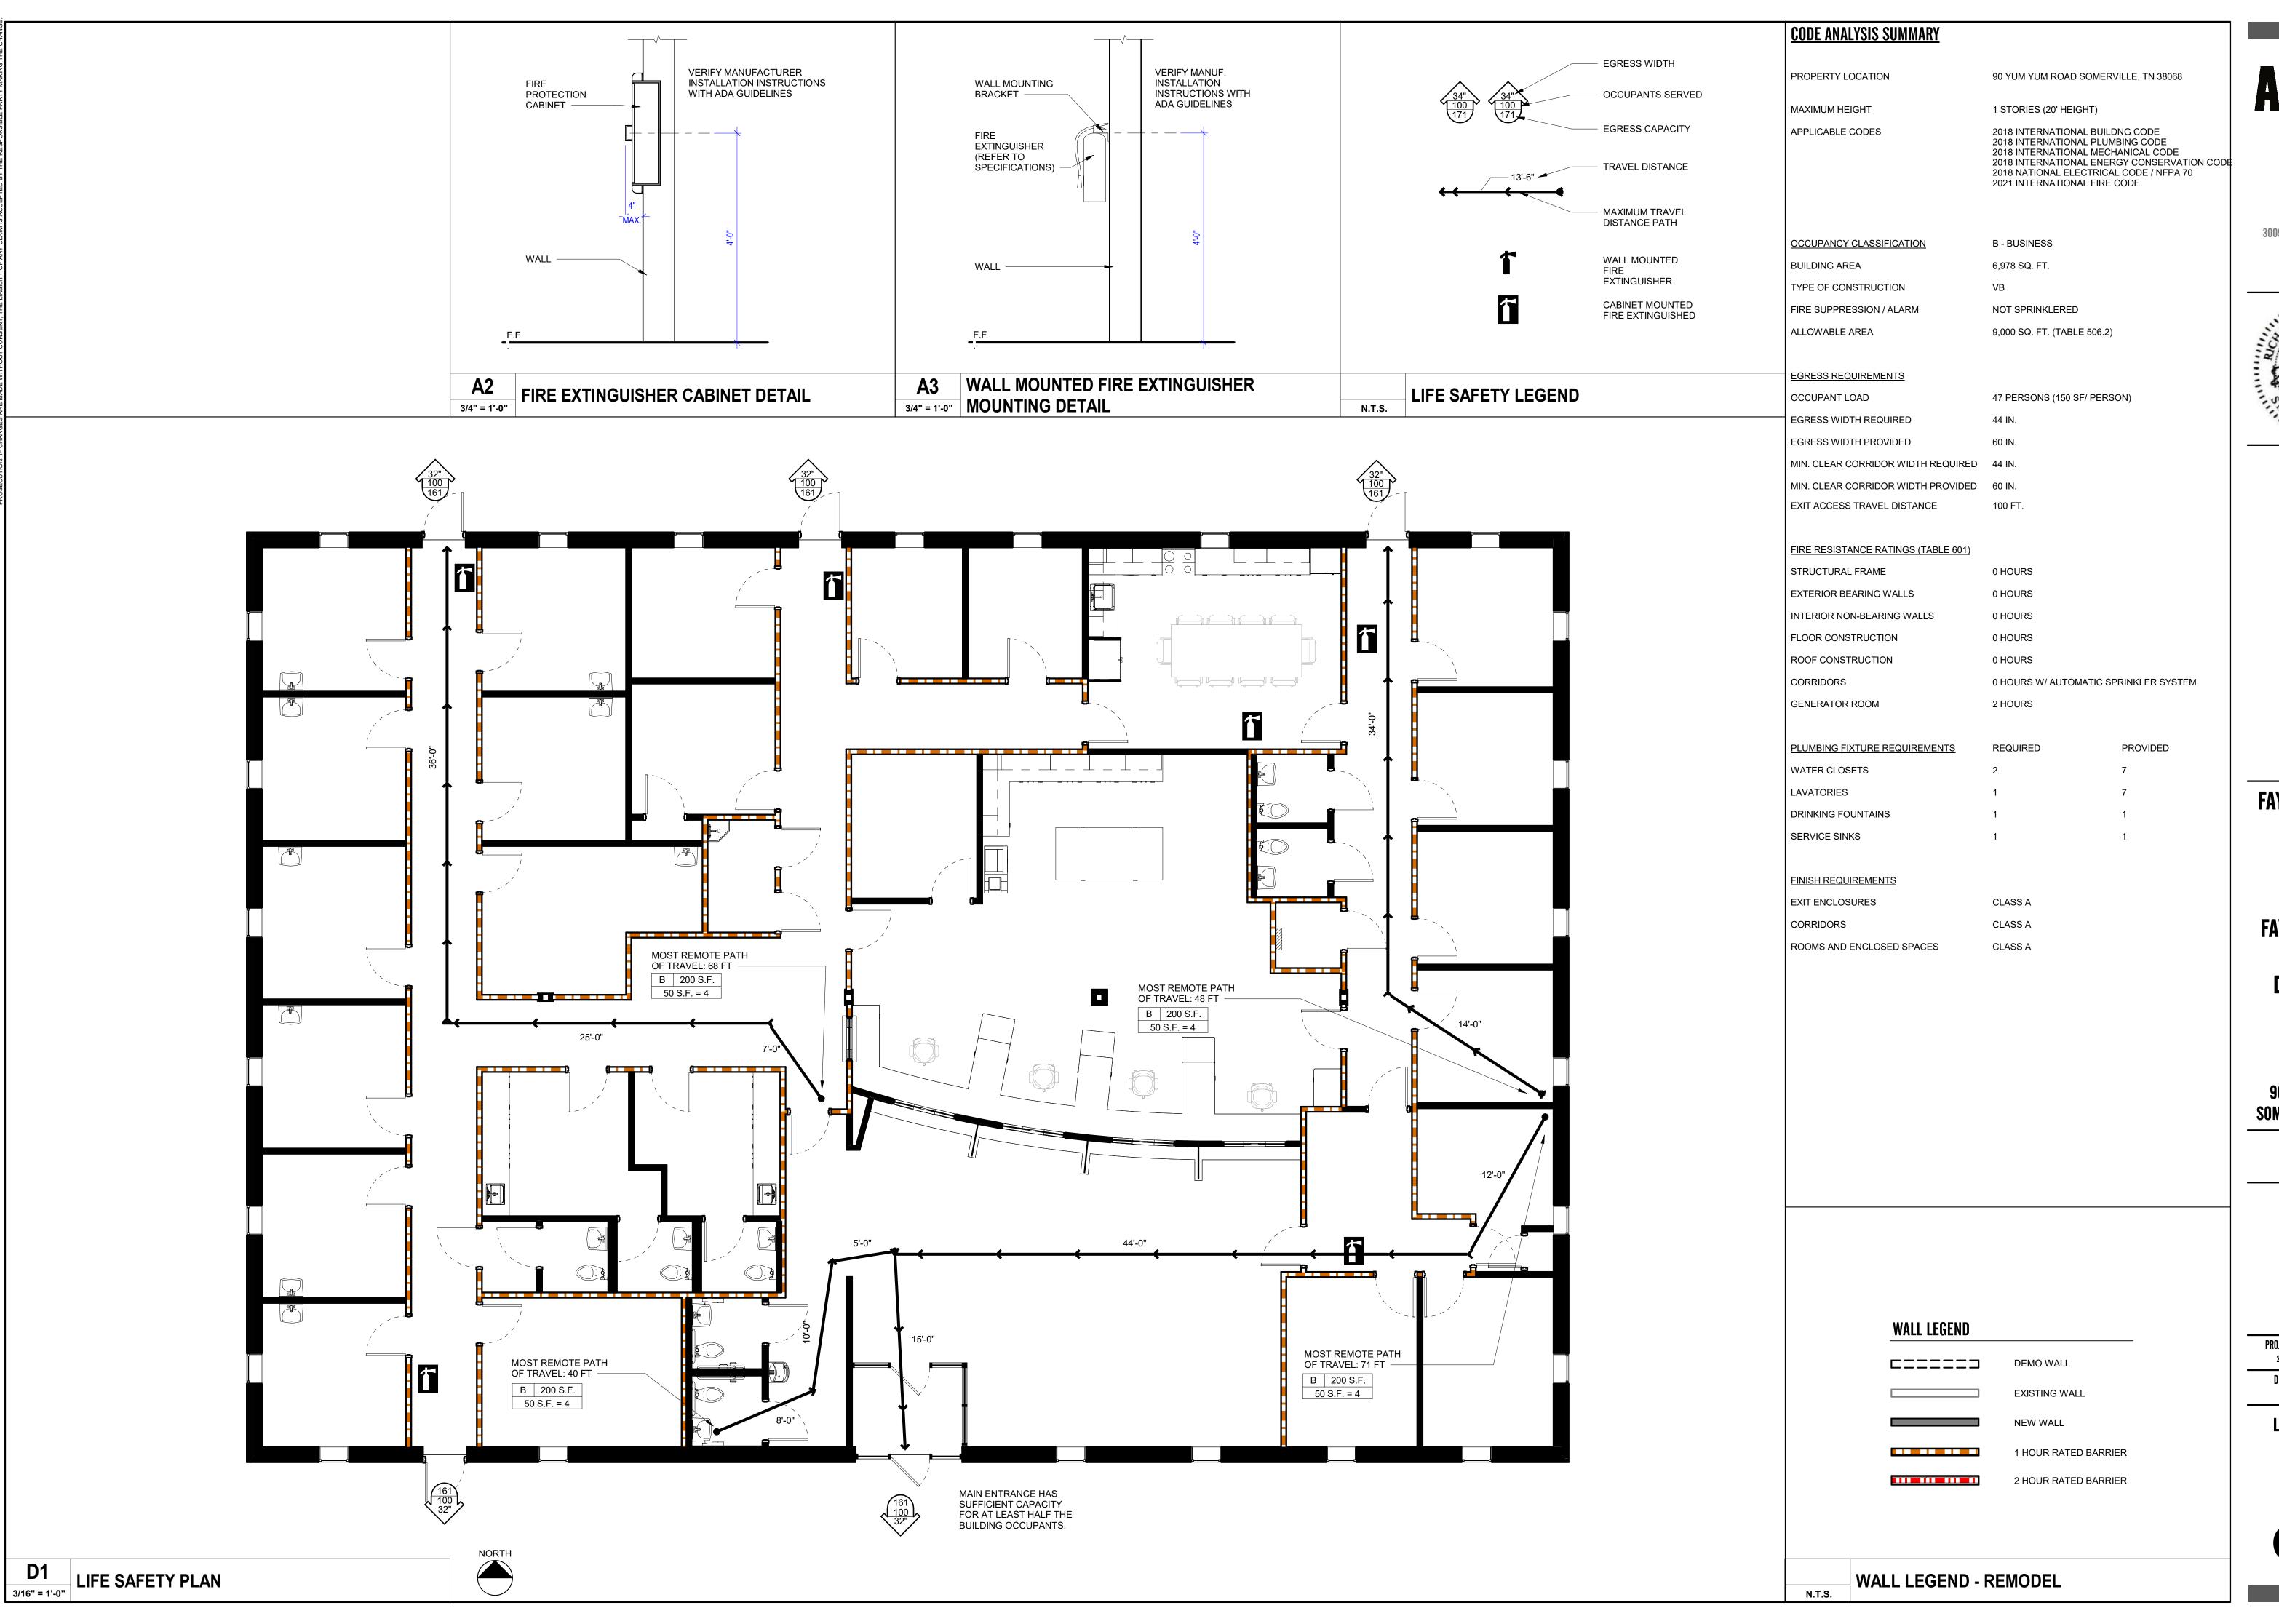



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3009 DAVIES PLANTATION ROAD
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FAYETTE COUNTY, TN

FAYETTE COUNTY
HEALTH
DEPARTMENT

90 YUM YUM ROAD SOMERVILLE, TN 38068

CONSTRUCTION DOCUMENTS

REVISIONS

PROJECT NO.	DATE
23406	JUNE 20, 2024
DRAWN	CHECKED
LL	RHM

LIFE SAFETY PLAN

G0.2





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DEPARTMENT

90 YUM YUM ROAD SOMERVILLE, TN 38068

CONSTRUCTION DOCUMENTS


REVISIONS

PROJECT NO. DATE
23406 JUNE 20, 2024

DRAWN CHECKED
LL RHM

FLOOR PLAN - EXISTING / DEMOLITION


A0.1

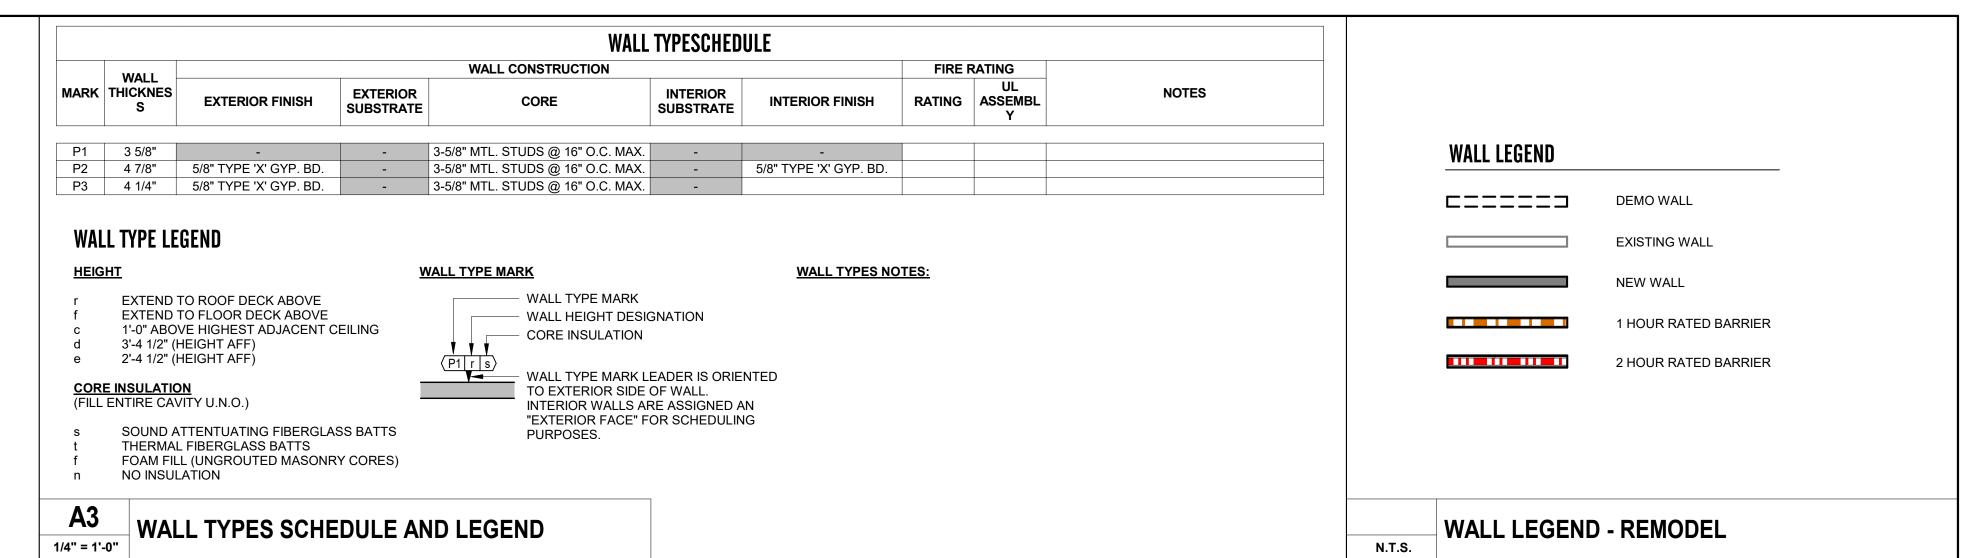



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3/16" = 1'-0"

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CONSTRUCTION DOCUMENTS

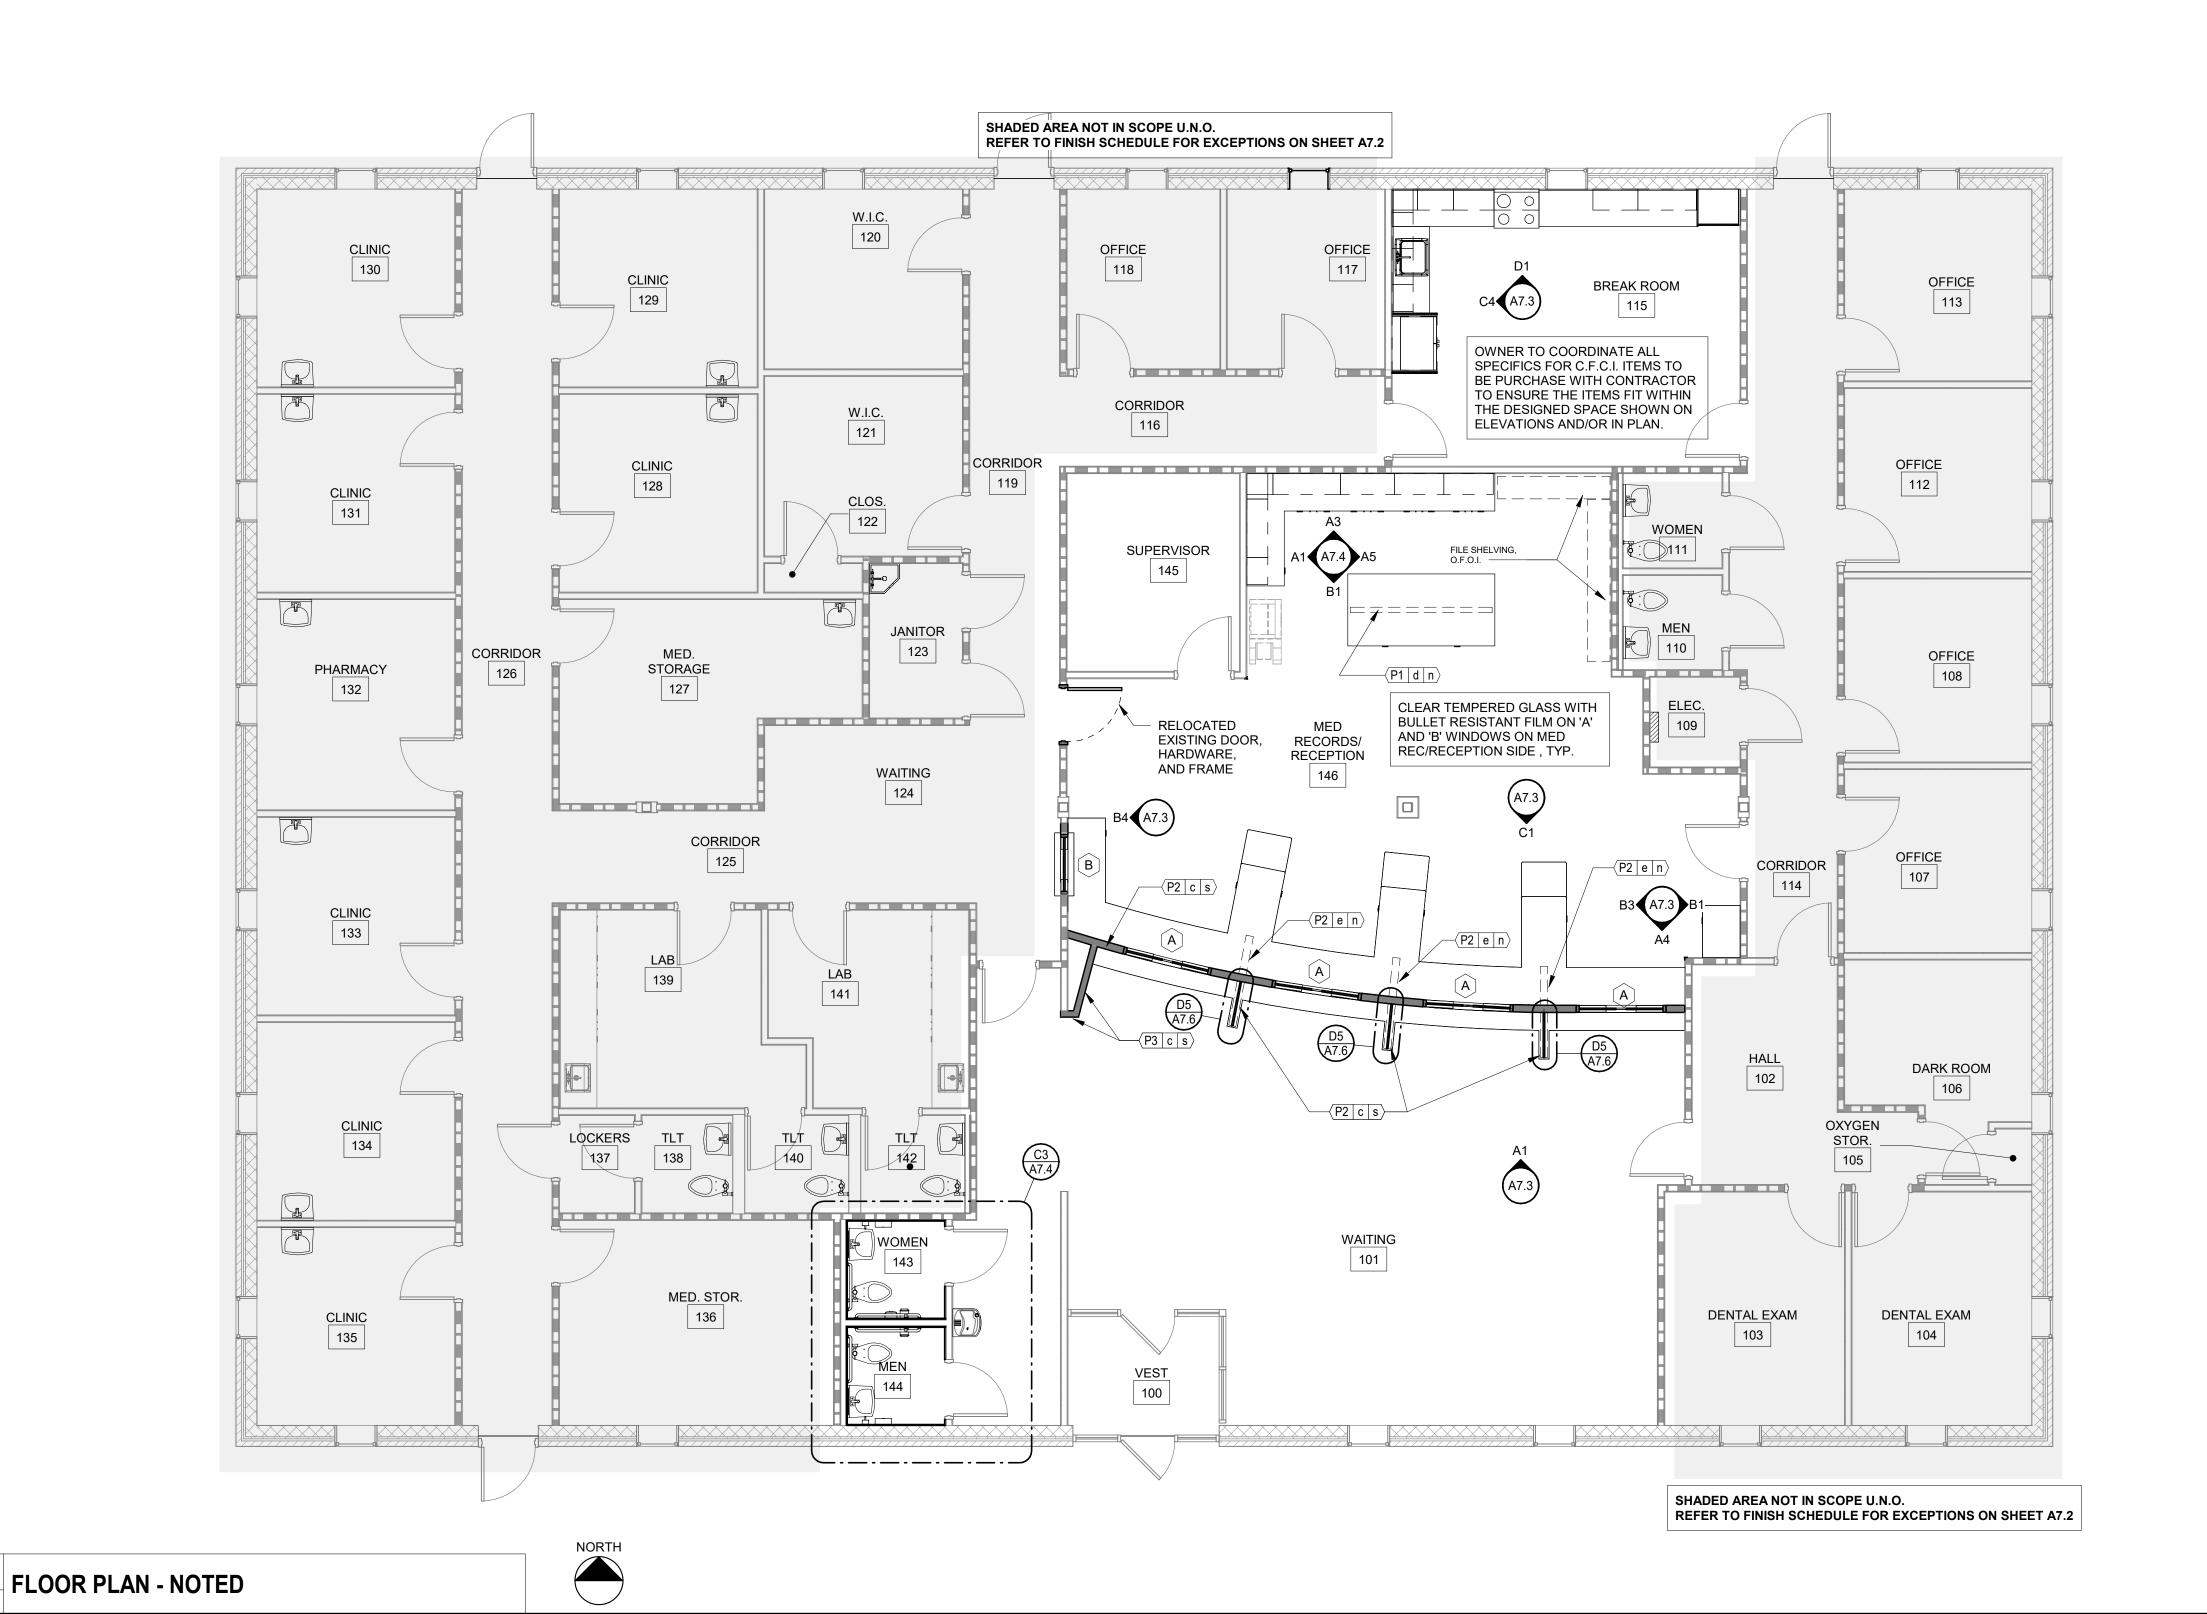
REVISIONS

PROJECT NO. DATE
23406 JUNE 20, 2024

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FLOOR PLAN - NOTED

A1.0



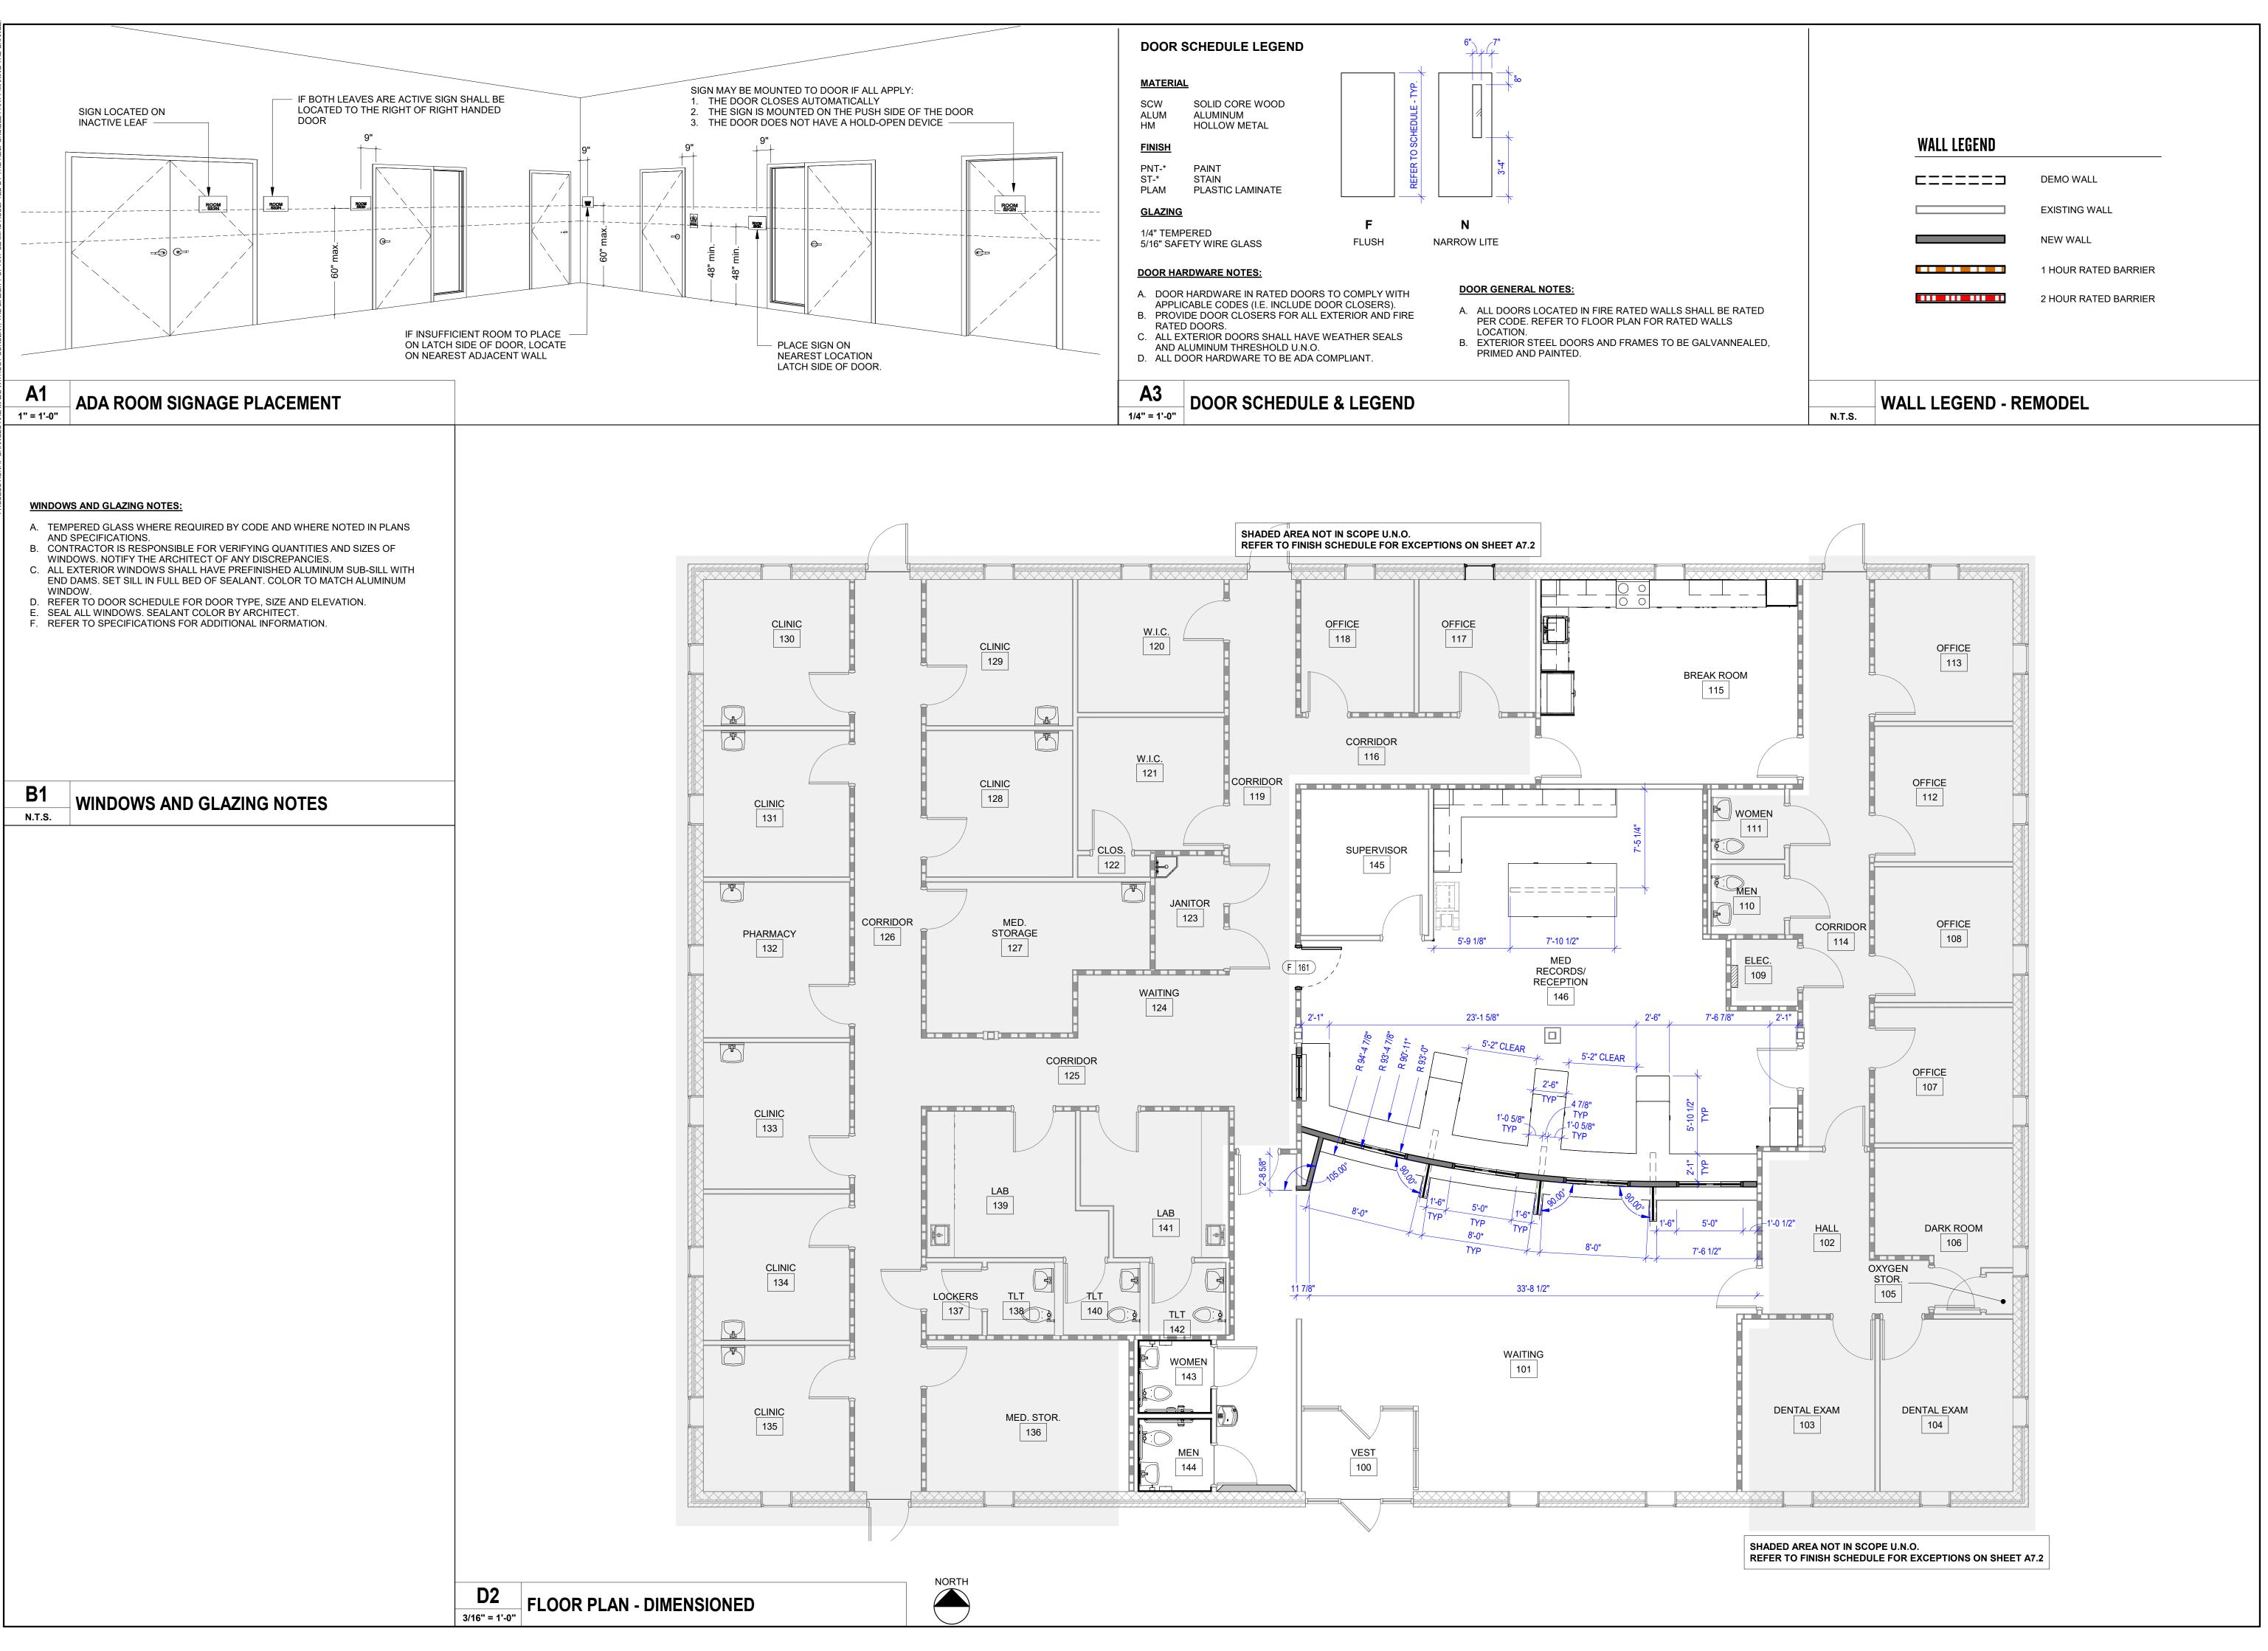

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HEALTH
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90 YUM YUM ROAD SOMERVILLE, TN 38068

CONSTRUCTION DOCUMENTS


REVISIONS

PROJECT NO. DATE
23406 JUNE 20, 2024

DRAWN CHECKED

FLOOR PLAN -DIMENSIIONED


A1.1

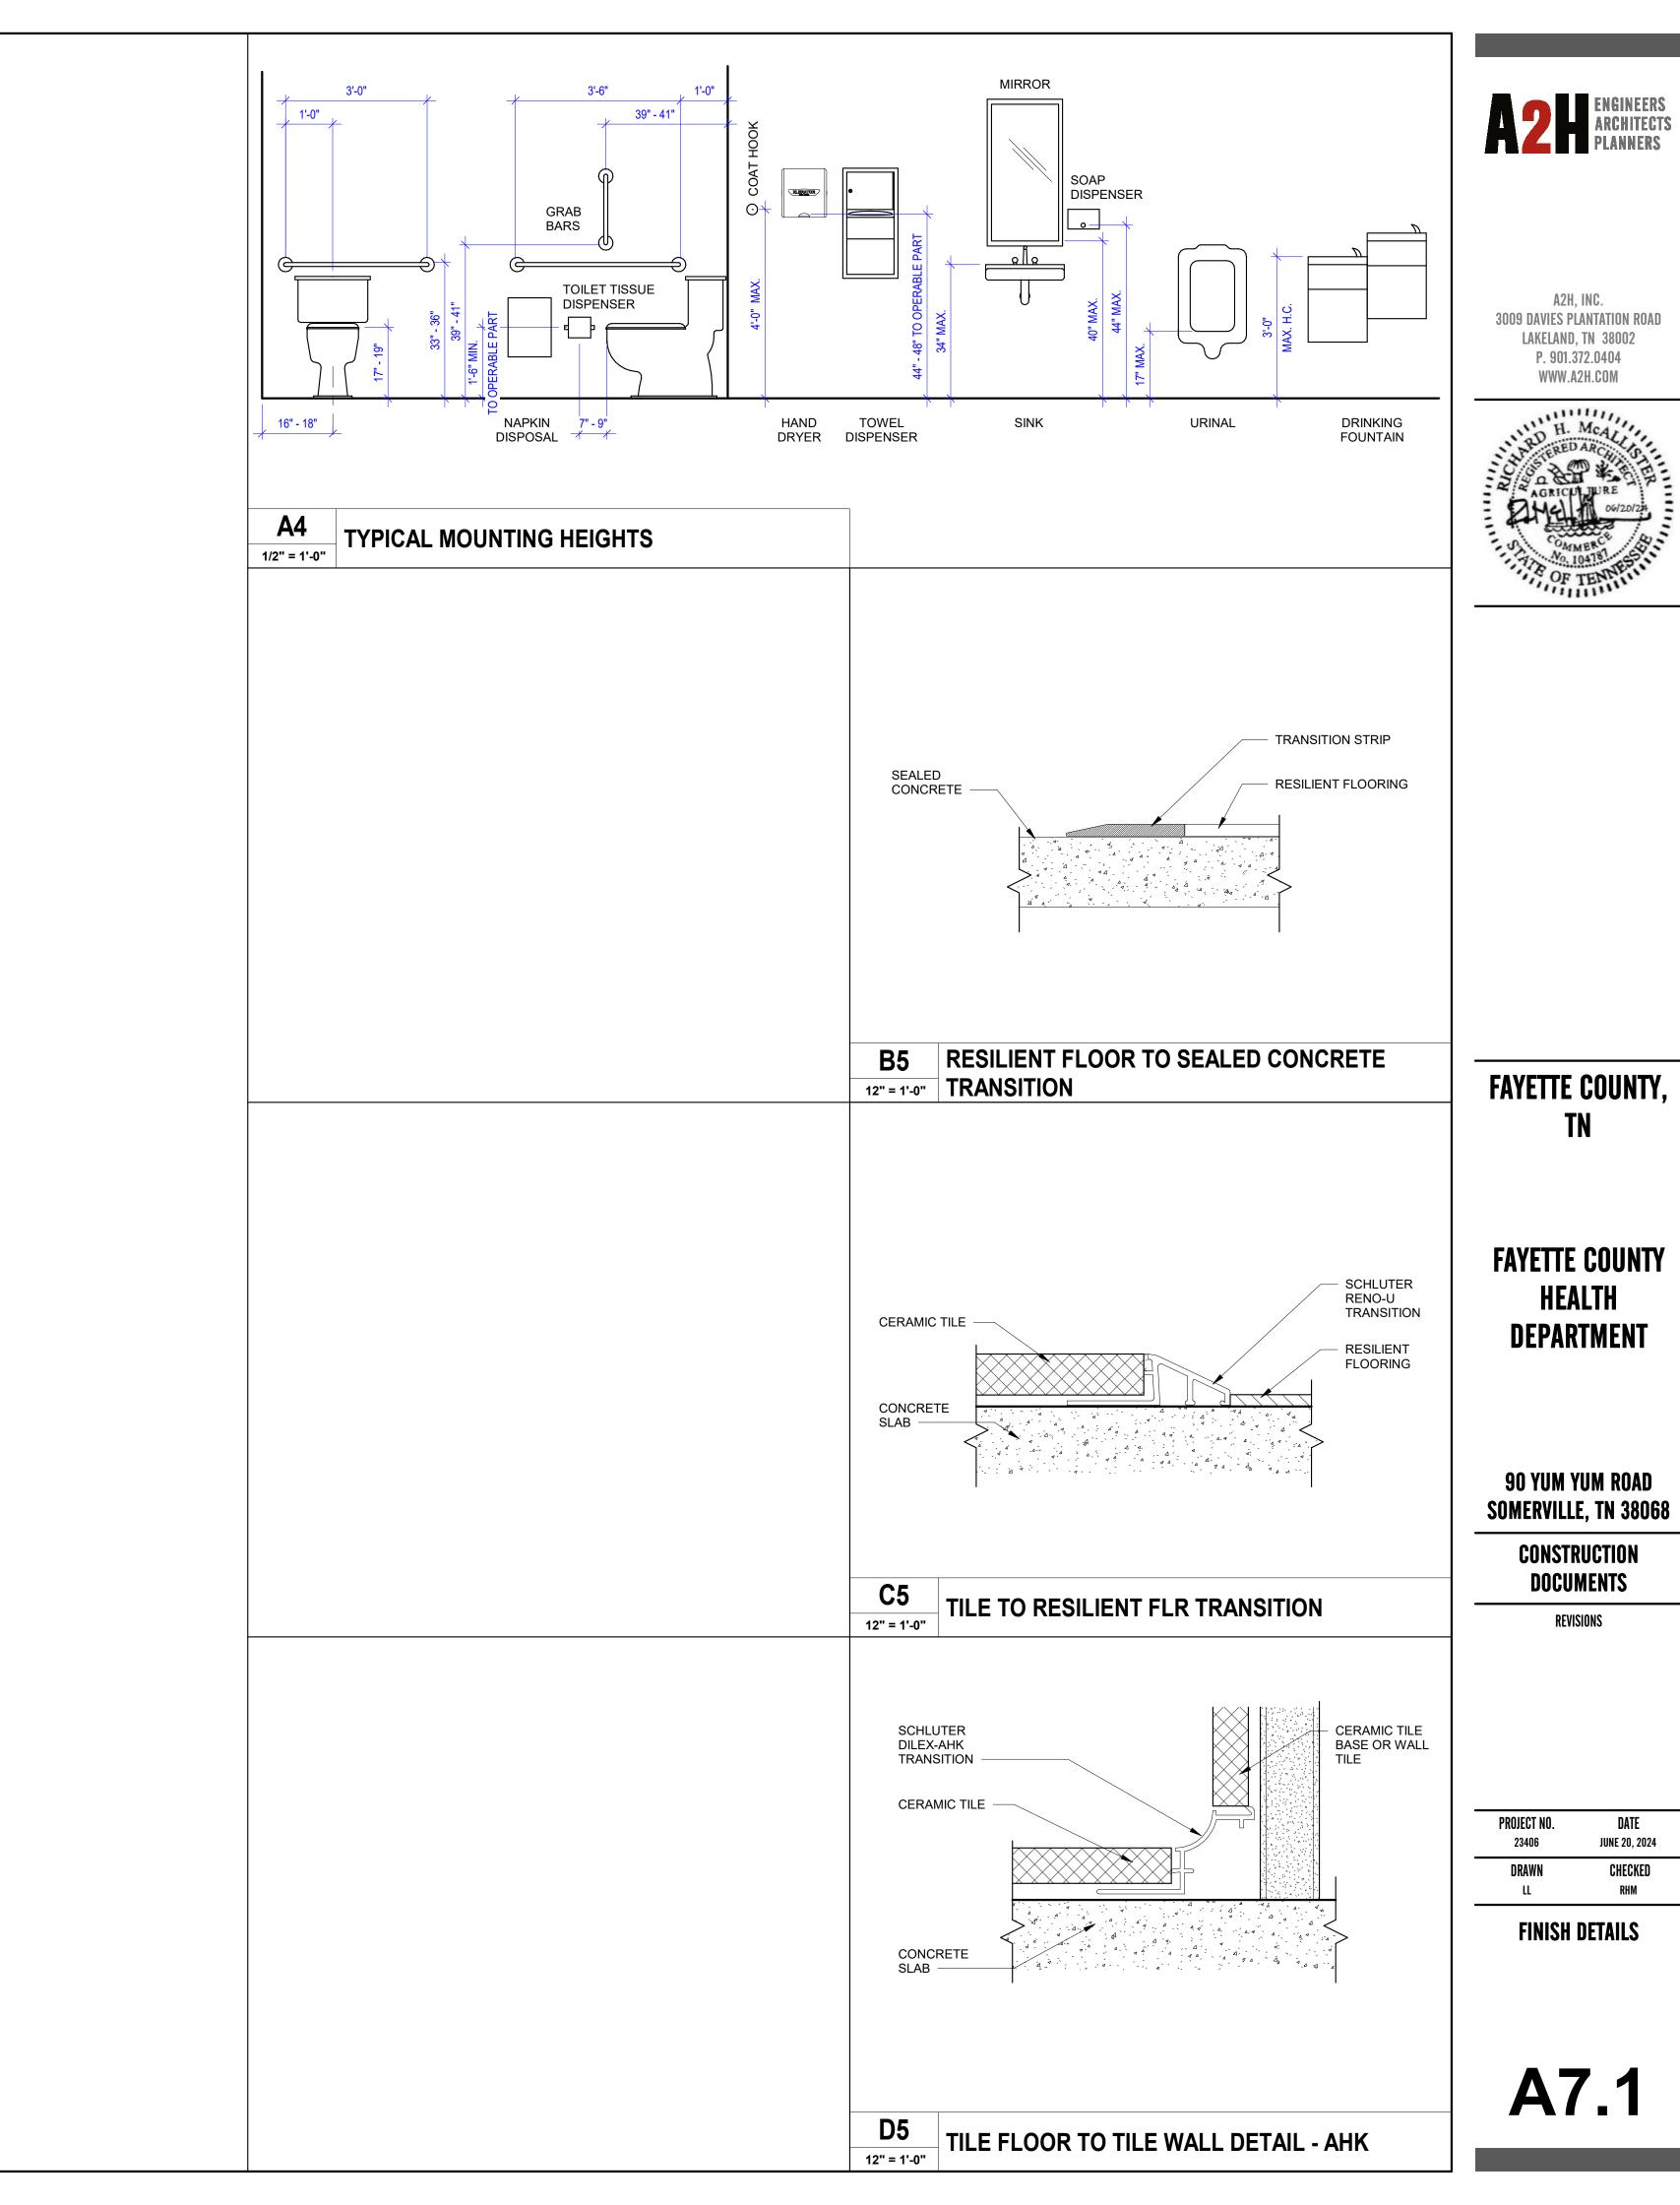





	FINISH SCHE	DULE			FINISH SCHEDULE	
NUMBER	NAME	FLOOR FINISH	BASE FINISH	WALL FINISH	CEILING FINISH	COMMENTS
100	VEST	CPT-1	WB-1	PNT-1	A1	
101	WAITING	LVT-1/LVT-2	WB-1	PNT-1	A1	
102	HALL	LVT-1	WB-1	PNT-1	ETR	
103	DENTAL EXAM	LVT-1	WB-1	PNT-1	ETR	
104	DENTAL EXAM	LVT-1	WB-1	PNT-1	ETR	
105	OXYGEN STOR.	LVT-1	WB-1	PNT-1	ETR	
106	DARK ROOM	LVT-1	WB-1	PNT-1	ETR	
107	OFFICE	LVT-1	WB-1	PNT-1	ETR	
108	OFFICE	LVT-1	WB-1	PNT-1	ETR	
109	ELEC.	ETR	ETR	ETR	ETR	
110	MEN	ETR	ETR	ETR	ETR	
111	WOMEN	ETR	ETR	ETR	ETR	
112	OFFICE	LVT-1	WB-1	PNT-1	ETR	
113	OFFICE	LVT-1	WB-1	PNT-1	ETR	
114	CORRIDOR	LVT-1	WB-1	PNT-1	ETR	
115	BREAK ROOM	LVT-1	WB-1	PNT-1	A1	
116	CORRIDOR	ETR	ETR	ETR	ETR	
117	OFFICE	ETR	ETR	ETR	ETR	
118	OFFICE	ETR	ETR	ETR	ETR	
119	CORRIDOR	ETR	ETR	ETR	ETR	
120	W.I.C.	ETR	ETR	ETR	ETR	
121	W.I.C.	ETR	ETR	ETR	ETR	
122	CLOS.	ETR	ETR	ETR	ETR	
123	JANITOR	ETR	ETR	ETR	ETR	
124	WAITING	ETR	ETR	ETR	ETR	
125	CORRIDOR	ETR	ETR	ETR	ETR	
126	CORRIDOR	ETR	ETR	ETR	ETR	
127	MED. STORAGE		ETR	ETR	ETR	
		ETR				
128	CLINIC	ETR	ETR	ETR	ETR	
129	CLINIC	ETR	ETR	ETR	ETR	
130	CLINIC	ETR	ETR	ETR	ETR	
131	CLINIC	ETR	ETR	ETR	ETR	
132	PHARMACY	ETR	ETR	ETR	ETR	
133	CLINIC	ETR	ETR	ETR	ETR	
134	CLINIC	ETR	ETR	ETR	ETR	
135	CLINIC	ETR	ETR	ETR	ETR	
136	MED. STOR.	ETR	ETR	ETR	ETR	
137	LOCKERS	ETR	ETR	ETR	ETR	
138	TLT	ETR	ETR	ETR	ETR	
139	LAB	ETR	ETR	ETR	ETR	
140	TLT	ETR	ETR	ETR	ETR	
141	LAB	ETR	ETR	ETR	ETR	
142	TLT	ETR	ETR	ETR	ETR	
143	WOMEN	T-1	T-2	T-2	A1	
144	MEN	T-1	T-2	T-2	A1	
145	SUPERVISOR	LVT-1	WB-1	PNT-1	A2	
146	MED RECORDS/ RECEPTION	LVT-1	WB-1	PNT-1	A1	

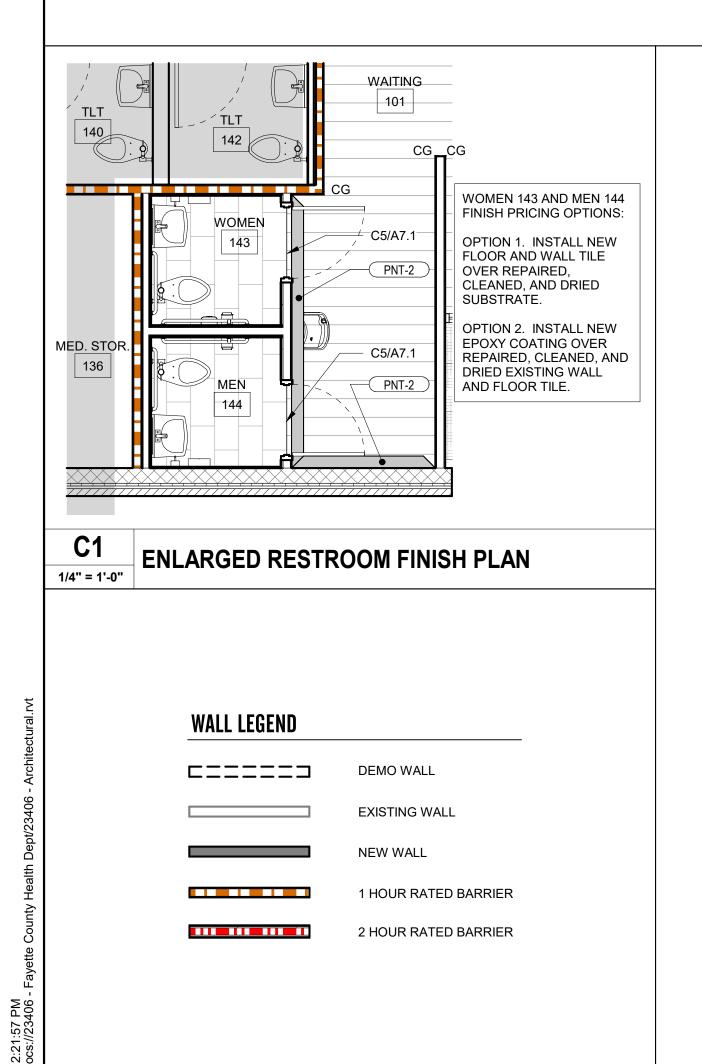

WALL LEGEND - REMODEL

N.T.S.



ALL GWB SURFACES TO BE PNT-1 UNLESS OTHERWISE INDICATED.

A - ACOUSTIC CEILING TILE

G - CEILING GWB COLOR

CPT - CARPET

LVT - LUXURY VINYL TILE

PLAM - PLASTIC LAMINATE

PNT - PAINT COLOR

SC - SEALED CONCRETE

SLD - SOLID SURFACE


SV - SHEET VINYL

T - CERAMIC OR POCELAIN TILE


TWB - TILE WALL BASE

WB - WALL BASE

VCT - VINYL COMPOSITION TILE

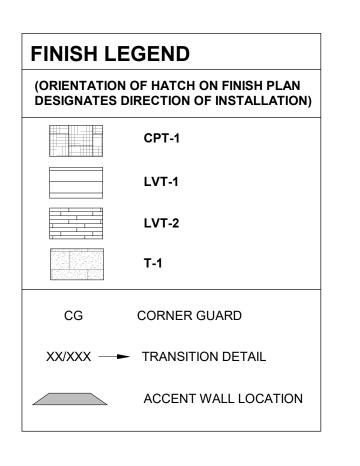

	MATERIAL SCHEDULE							
TAG	DESCRIPTION	SPEC	MANUFACTURER	NAME	COLOR	SIZE	INSTALL	COMMENTS
CARPET								
CARPET	CARPET TILE	09 6813	J&J FLOORING - KINETEX	DOWNTOWN	3153 ROUTE 66	24X24	ASHLAR	
01 1 1	O/ II	00 0010	OGO I EGORANG I KINETEX	Бомитоми	01001001200	247(24	/ COLLY III	I
LUXURY VI	NYL TILE							
LVT-2	LUXURY VINYL TILE	09 6500	MOHAWK GROUP	LARGE AND LOCAL WOOD C0128, 4.5MM	832 TELLICO	9.25"X59"	ASHLAR	ASHLAR INSTALLATION
LVT-1	LUXURY VINYL TILE	09 6500	MOHAWK GROUP	LARGE AND LOCAL WOOD C0128, 4.5MM	865 ROAN	9.25"X59"	ASHLAR	ASHLAR INSTALLATION
METAL	T							
SS-1	STAINLESS STEEL		TBD					
MISC								
CG	WALL PROTECTION	10 2601	INPRO	TYPE	0238 FEATHER	48" HIGH	2" ABOVE WALL BASE	CORNER GUARDS
30	,,,,,,,,,,,,,,,,,,,,,,,,,,,,,,,,,,,,,,	10 2001	1.41.10	12	0200 i Li tiliLit	10 111011	2 ABOVE WALL BAGE	SOLUTE CONTROL
PAINT								
PNT-1	INTERIOR PAINT	09 9000	SHERWIN WILLIAMS	SNOWBOUND	SW 7004			PROMAR 200 ZERO VOC INTERIOR LATEX; EGGSHELL, U.N.C
PNT-2	INTERIOR PAINT	09 9000	SHERWIN WILLIAMS	UNUSUAL GRAY	SW 7059			PROMAR 200 ZERO VOC INTERIOR LATEX; EGGSHELL, U.N.C
PNT-3	INTERIOR PAINT	09 9000	SHERWIN WILLIAMS	REPOSE GRAY	SW 7015			PROMAR 200 ZERO VOC INTERIOR LATEX; EGGSHELL, U.N.C
PLASTIC LA								
PLAM-1	PLASTIC LAMINATE	06 4100	ARBORITE	W498-CW	ENTRANCED BLACK OAK			
PLAM-2	PLASTIC LAMINATE	06 4100	ARBORITE	W462-EV	SULAWESI HAZEL			
I LAWI-Z	I LASTIC LAWINATE	00 4 100	ARBORITE	VV +02-L V	JULAWLUTTIAZEL			
RESIN PAN	IEL							
RP-1	RESIN PANEL		3 FORM	VARIA ECORESIN	FRONT-SANDSTONE FO	1		BACK-F01 COLOR SKY
				1		-	1	1
SOLID SUR								
SLD-1	SOLID SURFACE	12 3600	MEGANITE	ACRYLIC SOLID SURFACE	704SA URBAN HABITAT			1/2" THICK SOLID SURFACE, BULLNOSE, EASED EDGES
TILE	DODOE! A = =	00.00==	DI ATEODIA 2017-1-27-2	la a u	N (0 D) (1 IN IE	101/04	1.0111.47	VOILTINGV ODOLIT LATIOTTE TERMINATION
T-1	PORCELAIN TILE	09 3000	PLATFORM SURFACES	SOUL	IVORY LINE	12X24	ASHLAR	1/8" THICK GROUT, LATICRET PERMACOLOR, 35 MOCHA
T-2	PORCELAIN TILE	09 3000	PLATFORM SURFACES	SOUL	WHITE COTTON	12X24	ASHLAR	1/8" THICK GROUT, LATICRET PERMACOLOR, 35 MOCHA
WALL BASE	=							
WB-1	WALL BASE		JOHNSONITE/TARKETT	TYPE TP (THERMOPLASTIC RUBBER)	CHARCOAL 20			USE WITH TOE, PREFAB INSIDE AND OUTSIDE CORNERS
.,,,,	, (22 5) (32		JOHN JOHN LINE	Z II (IIIZIMOI Z MOTIO NOBBEN)	3. II II (30) IL 20			COL WITH TOL, I TELL AS MODE AND COTOBE CONNECTO

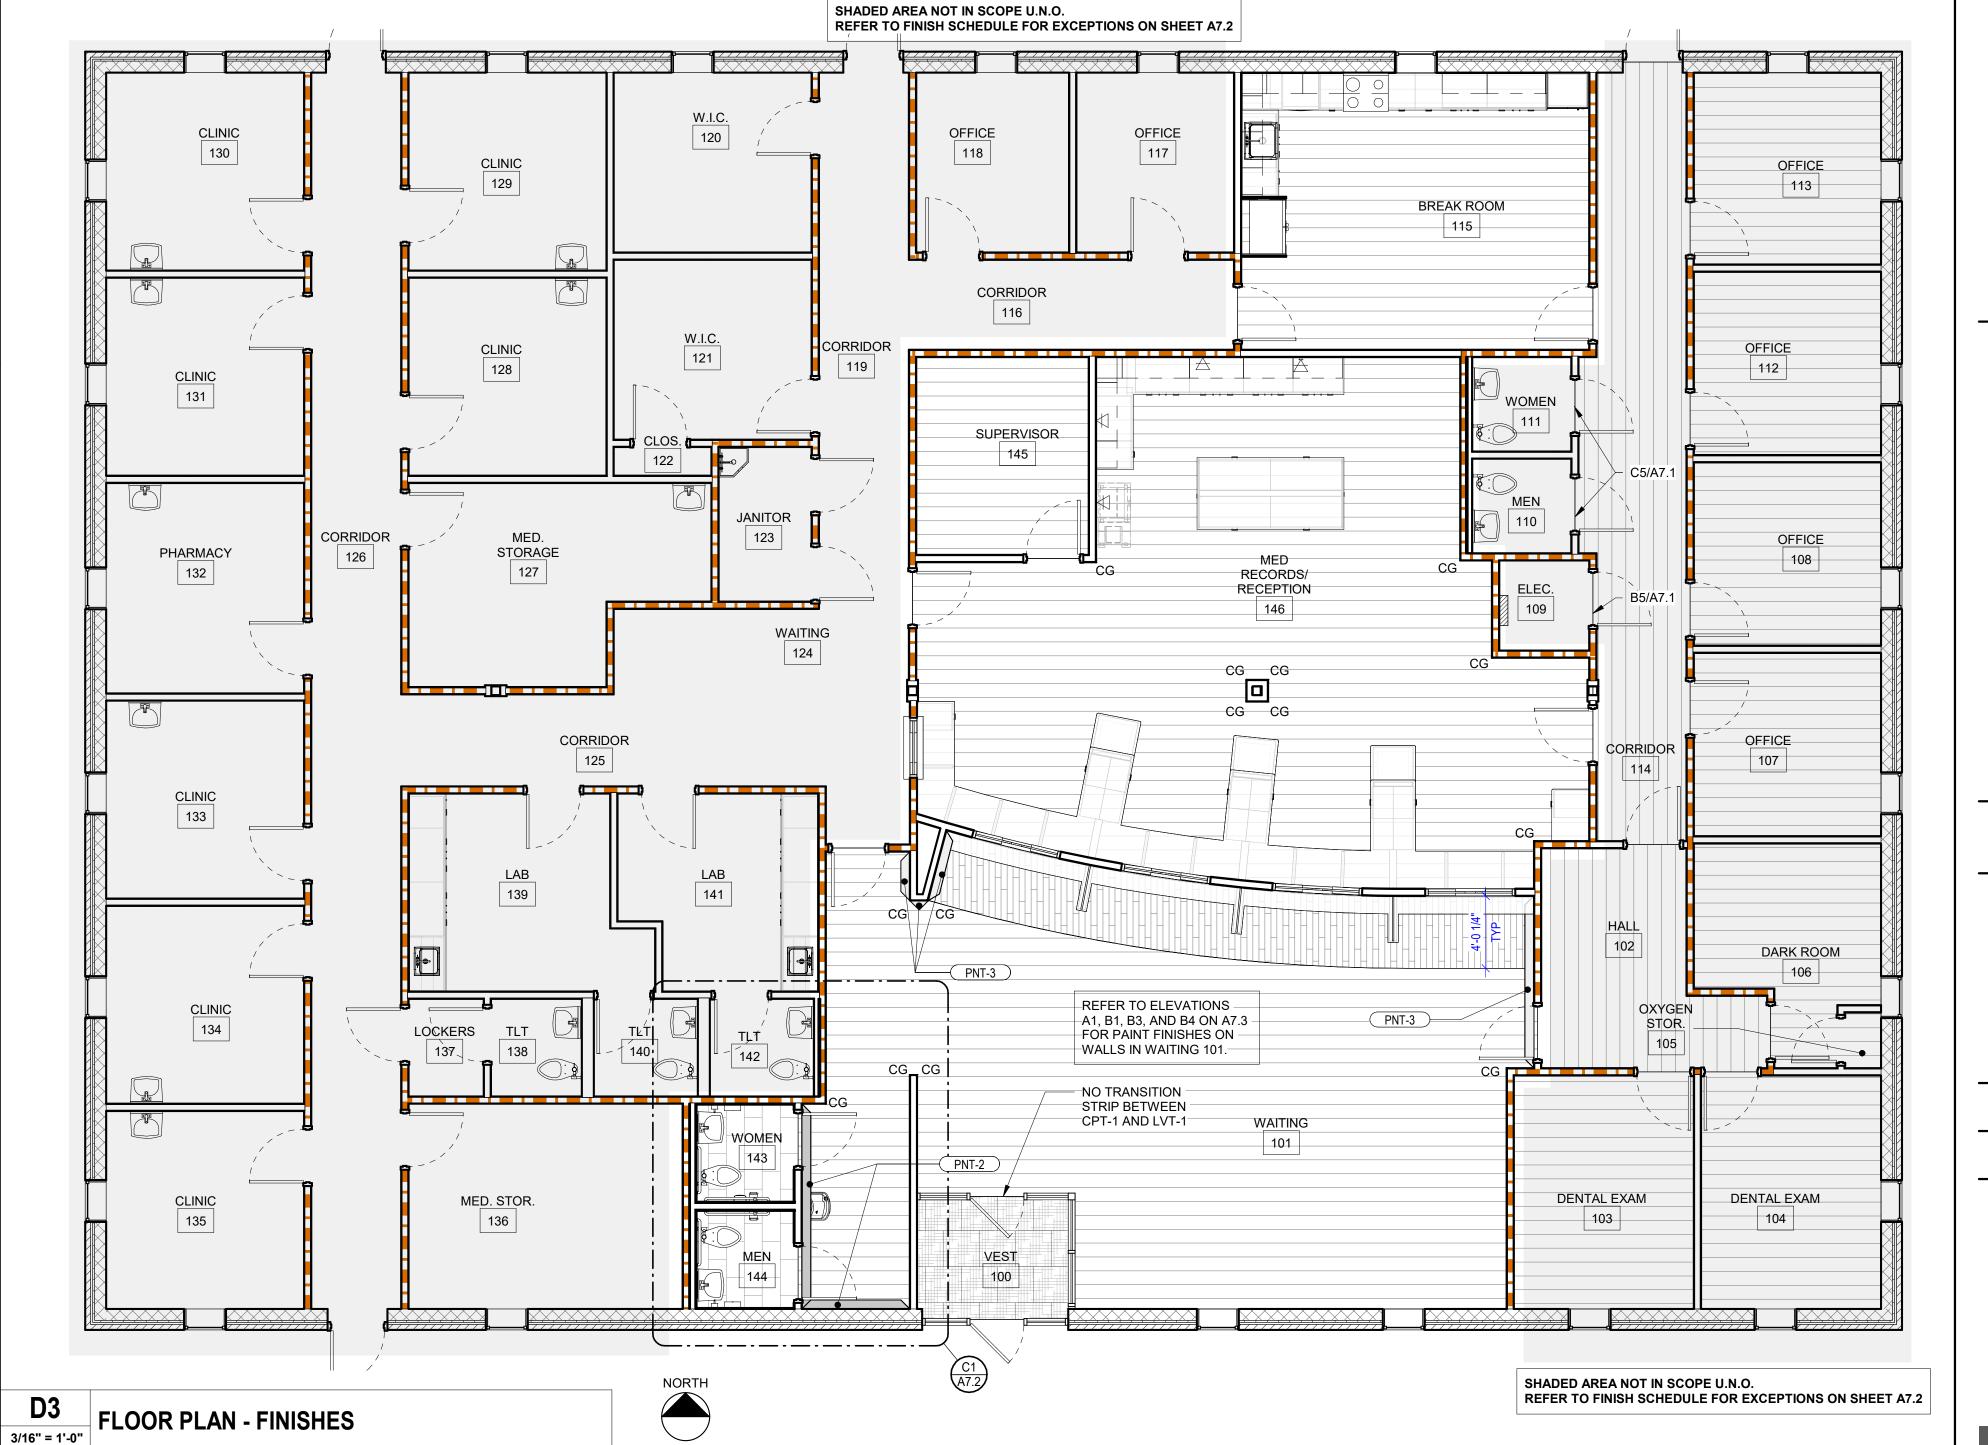



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FAYETTE COUNTY, TN

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HEALTH
DEPARTMENT

90 YUM YUM ROAD SOMERVILLE, TN 38068

CONSTRUCTION DOCUMENTS


REVISIONS

PROJECT NO. DATE
23406 JUNE 20, 2024

DRAWN CHECKED

FINISH PLAN AND SCHEDULES

A7.2

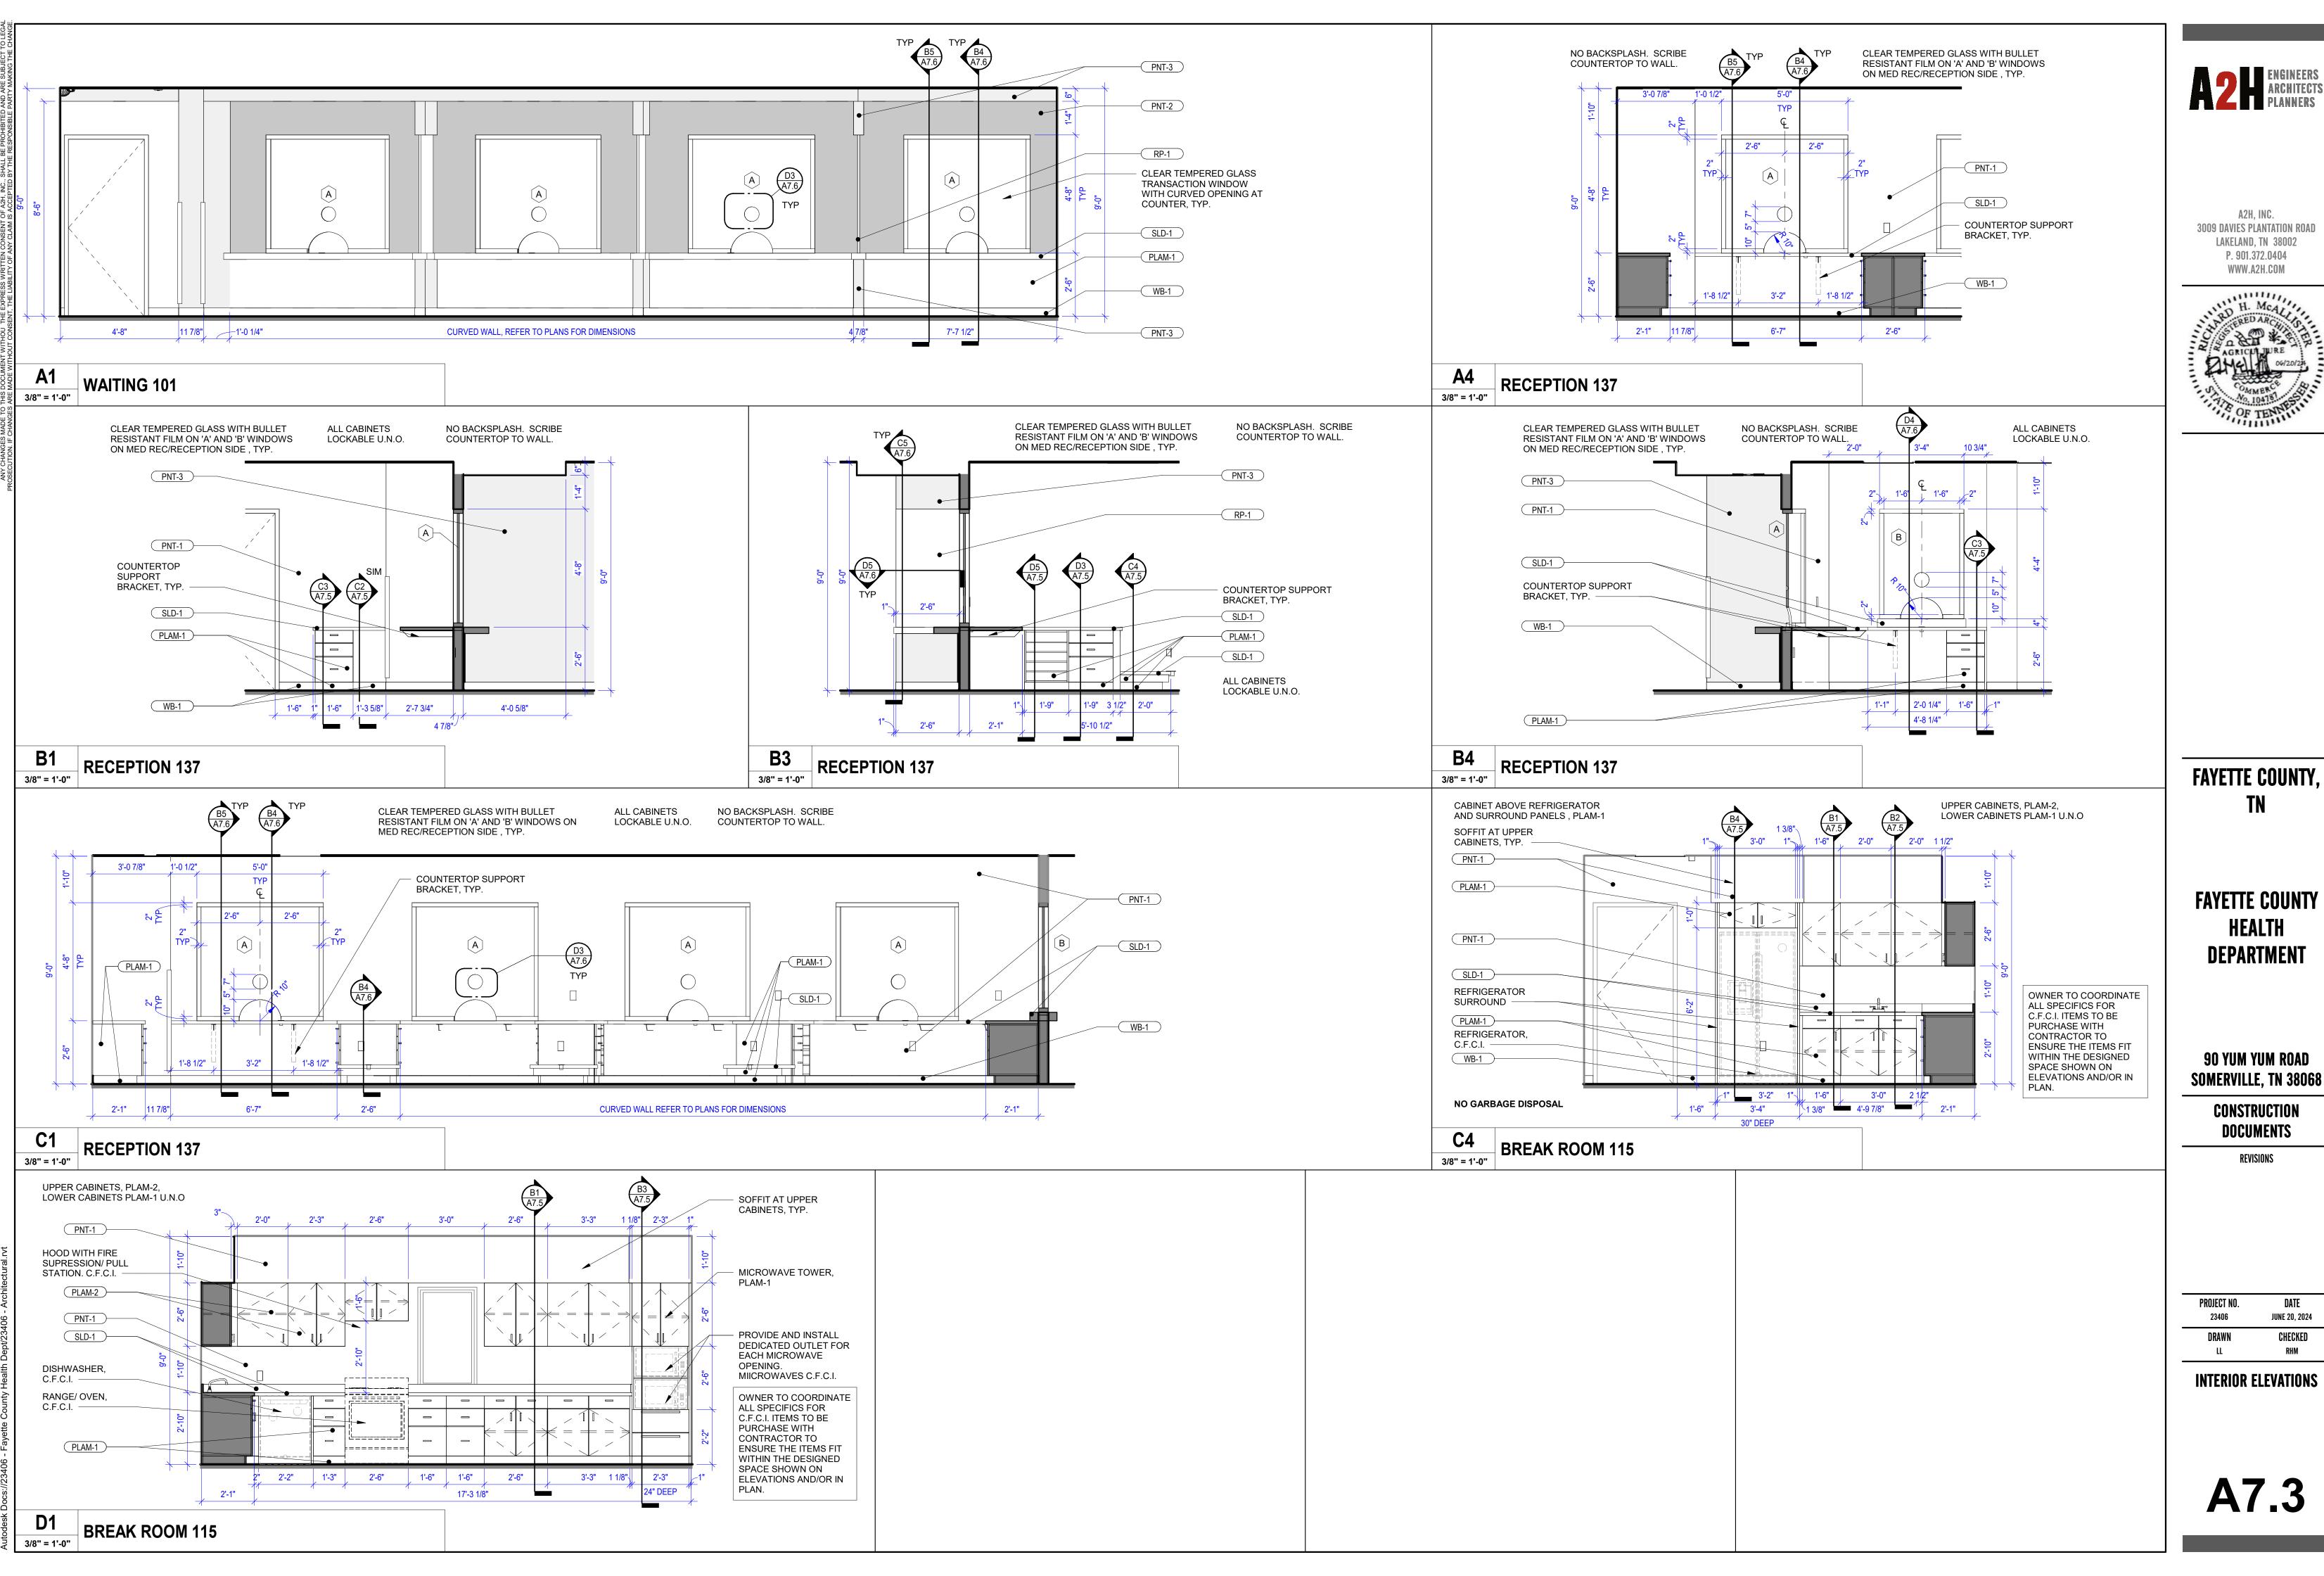

3009 DAVIES PLANTATION ROAD LAKELAND, TN 38002 P. 901.372.0404




FAYETTE COUNTY,

FAYETTE COUNTY HEALTH **DEPARTMENT**

90 YUM YUM ROAD

DATE JUNE 20, 2024 CHECKED

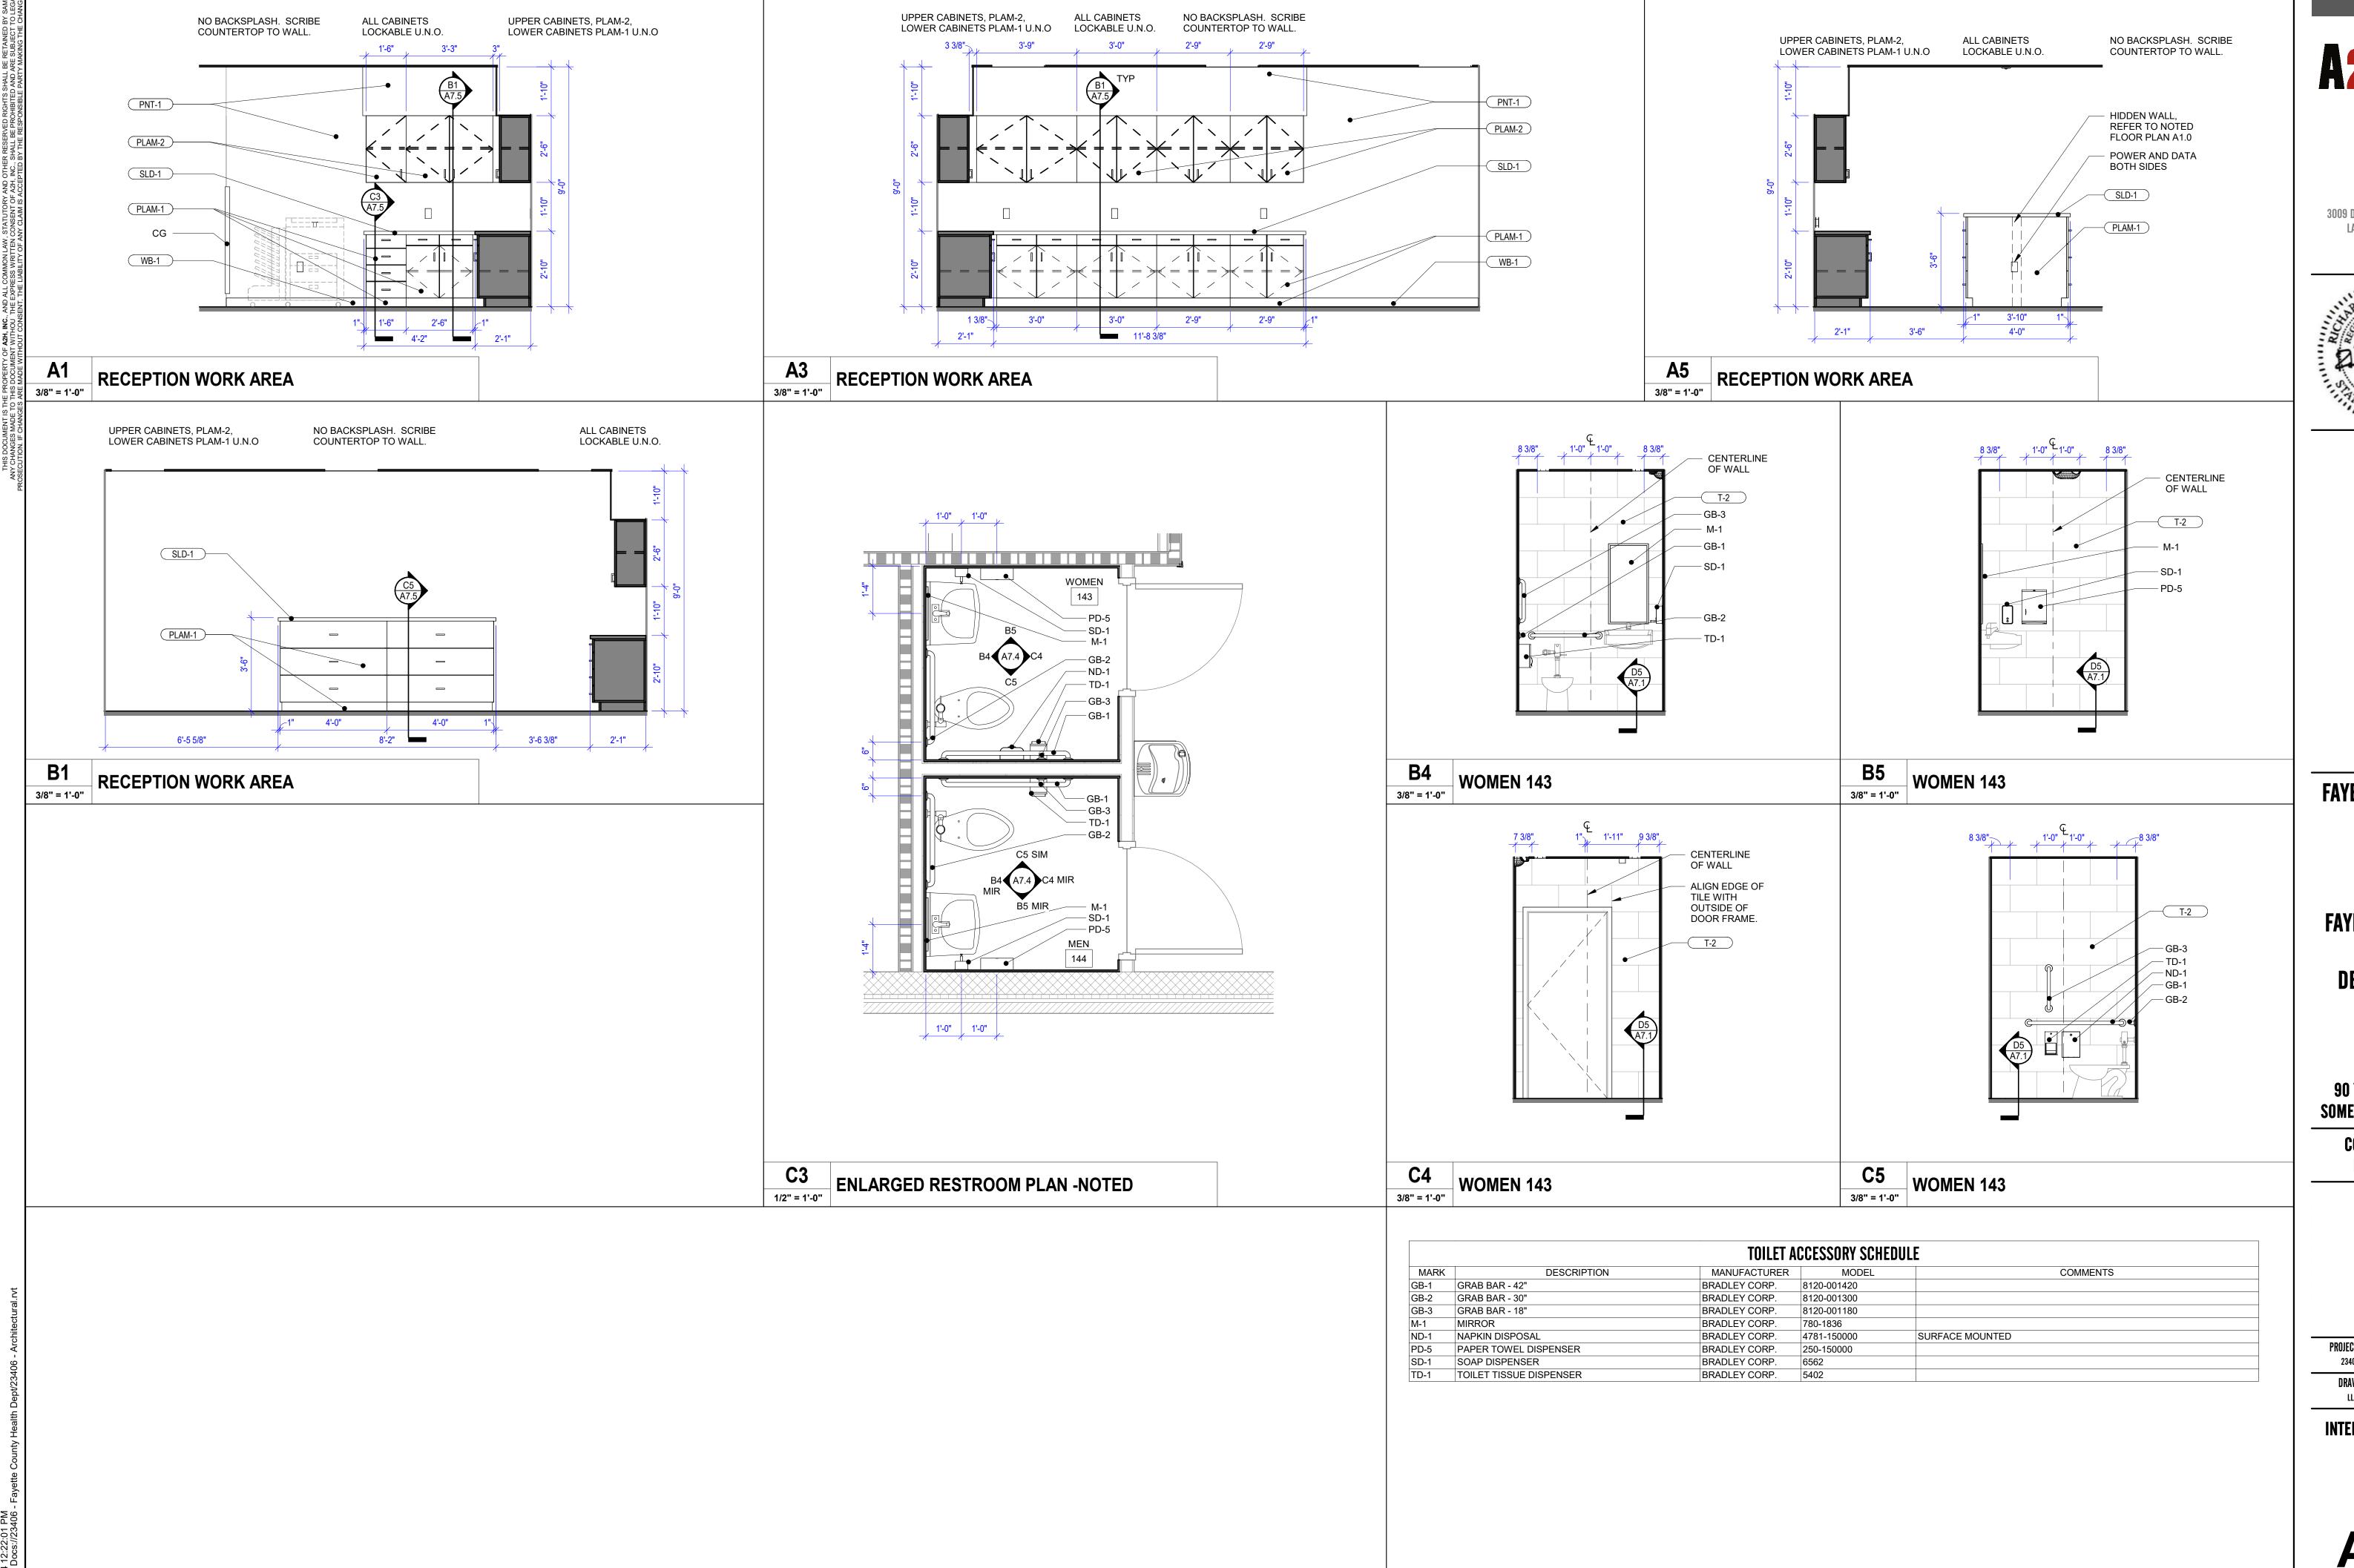

ENGINEERS ARCHITECTS PLANNERS

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FAYETTE COUNTY, TN

FAYETTE COUNTY
HEALTH
DEPARTMENT

90 YUM YUM ROAD SOMERVILLE, TN 38068

CONSTRUCTION DOCUMENTS


REVISIONS


PROJECT NO. DATE
23406 JUNE 20, 2024

CHECKED

INTERIOR ELEVATIONS

A7.4

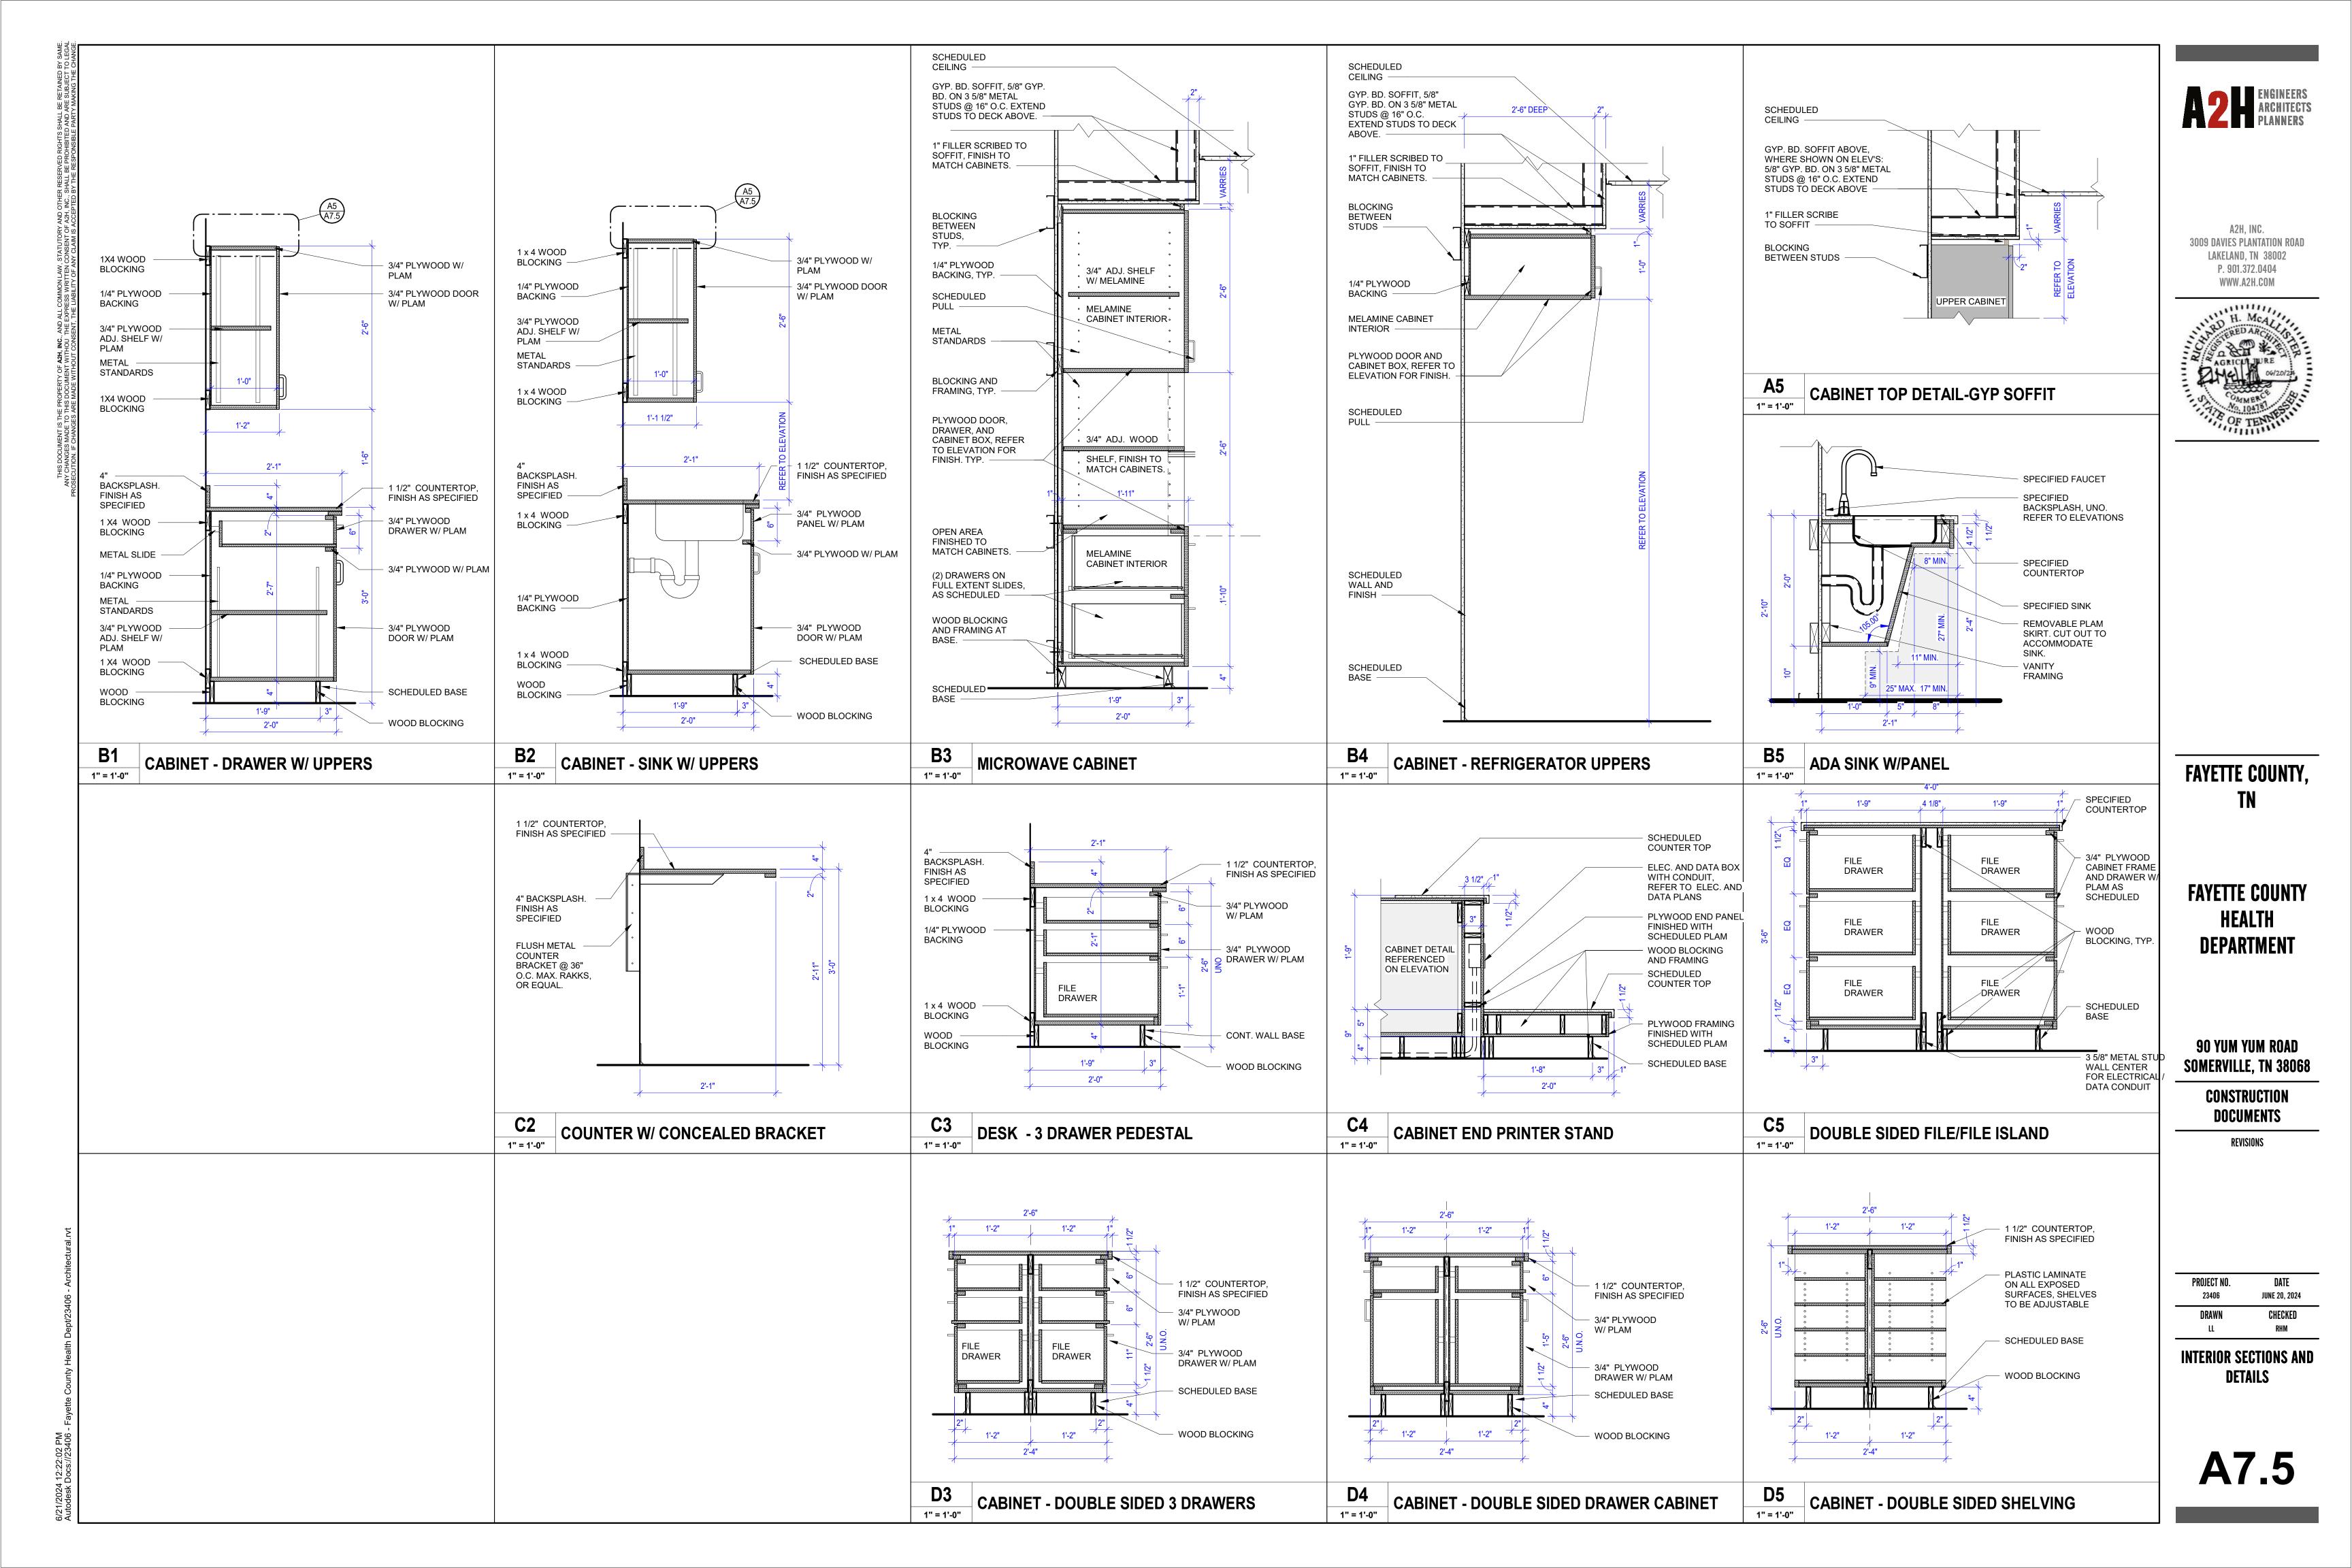

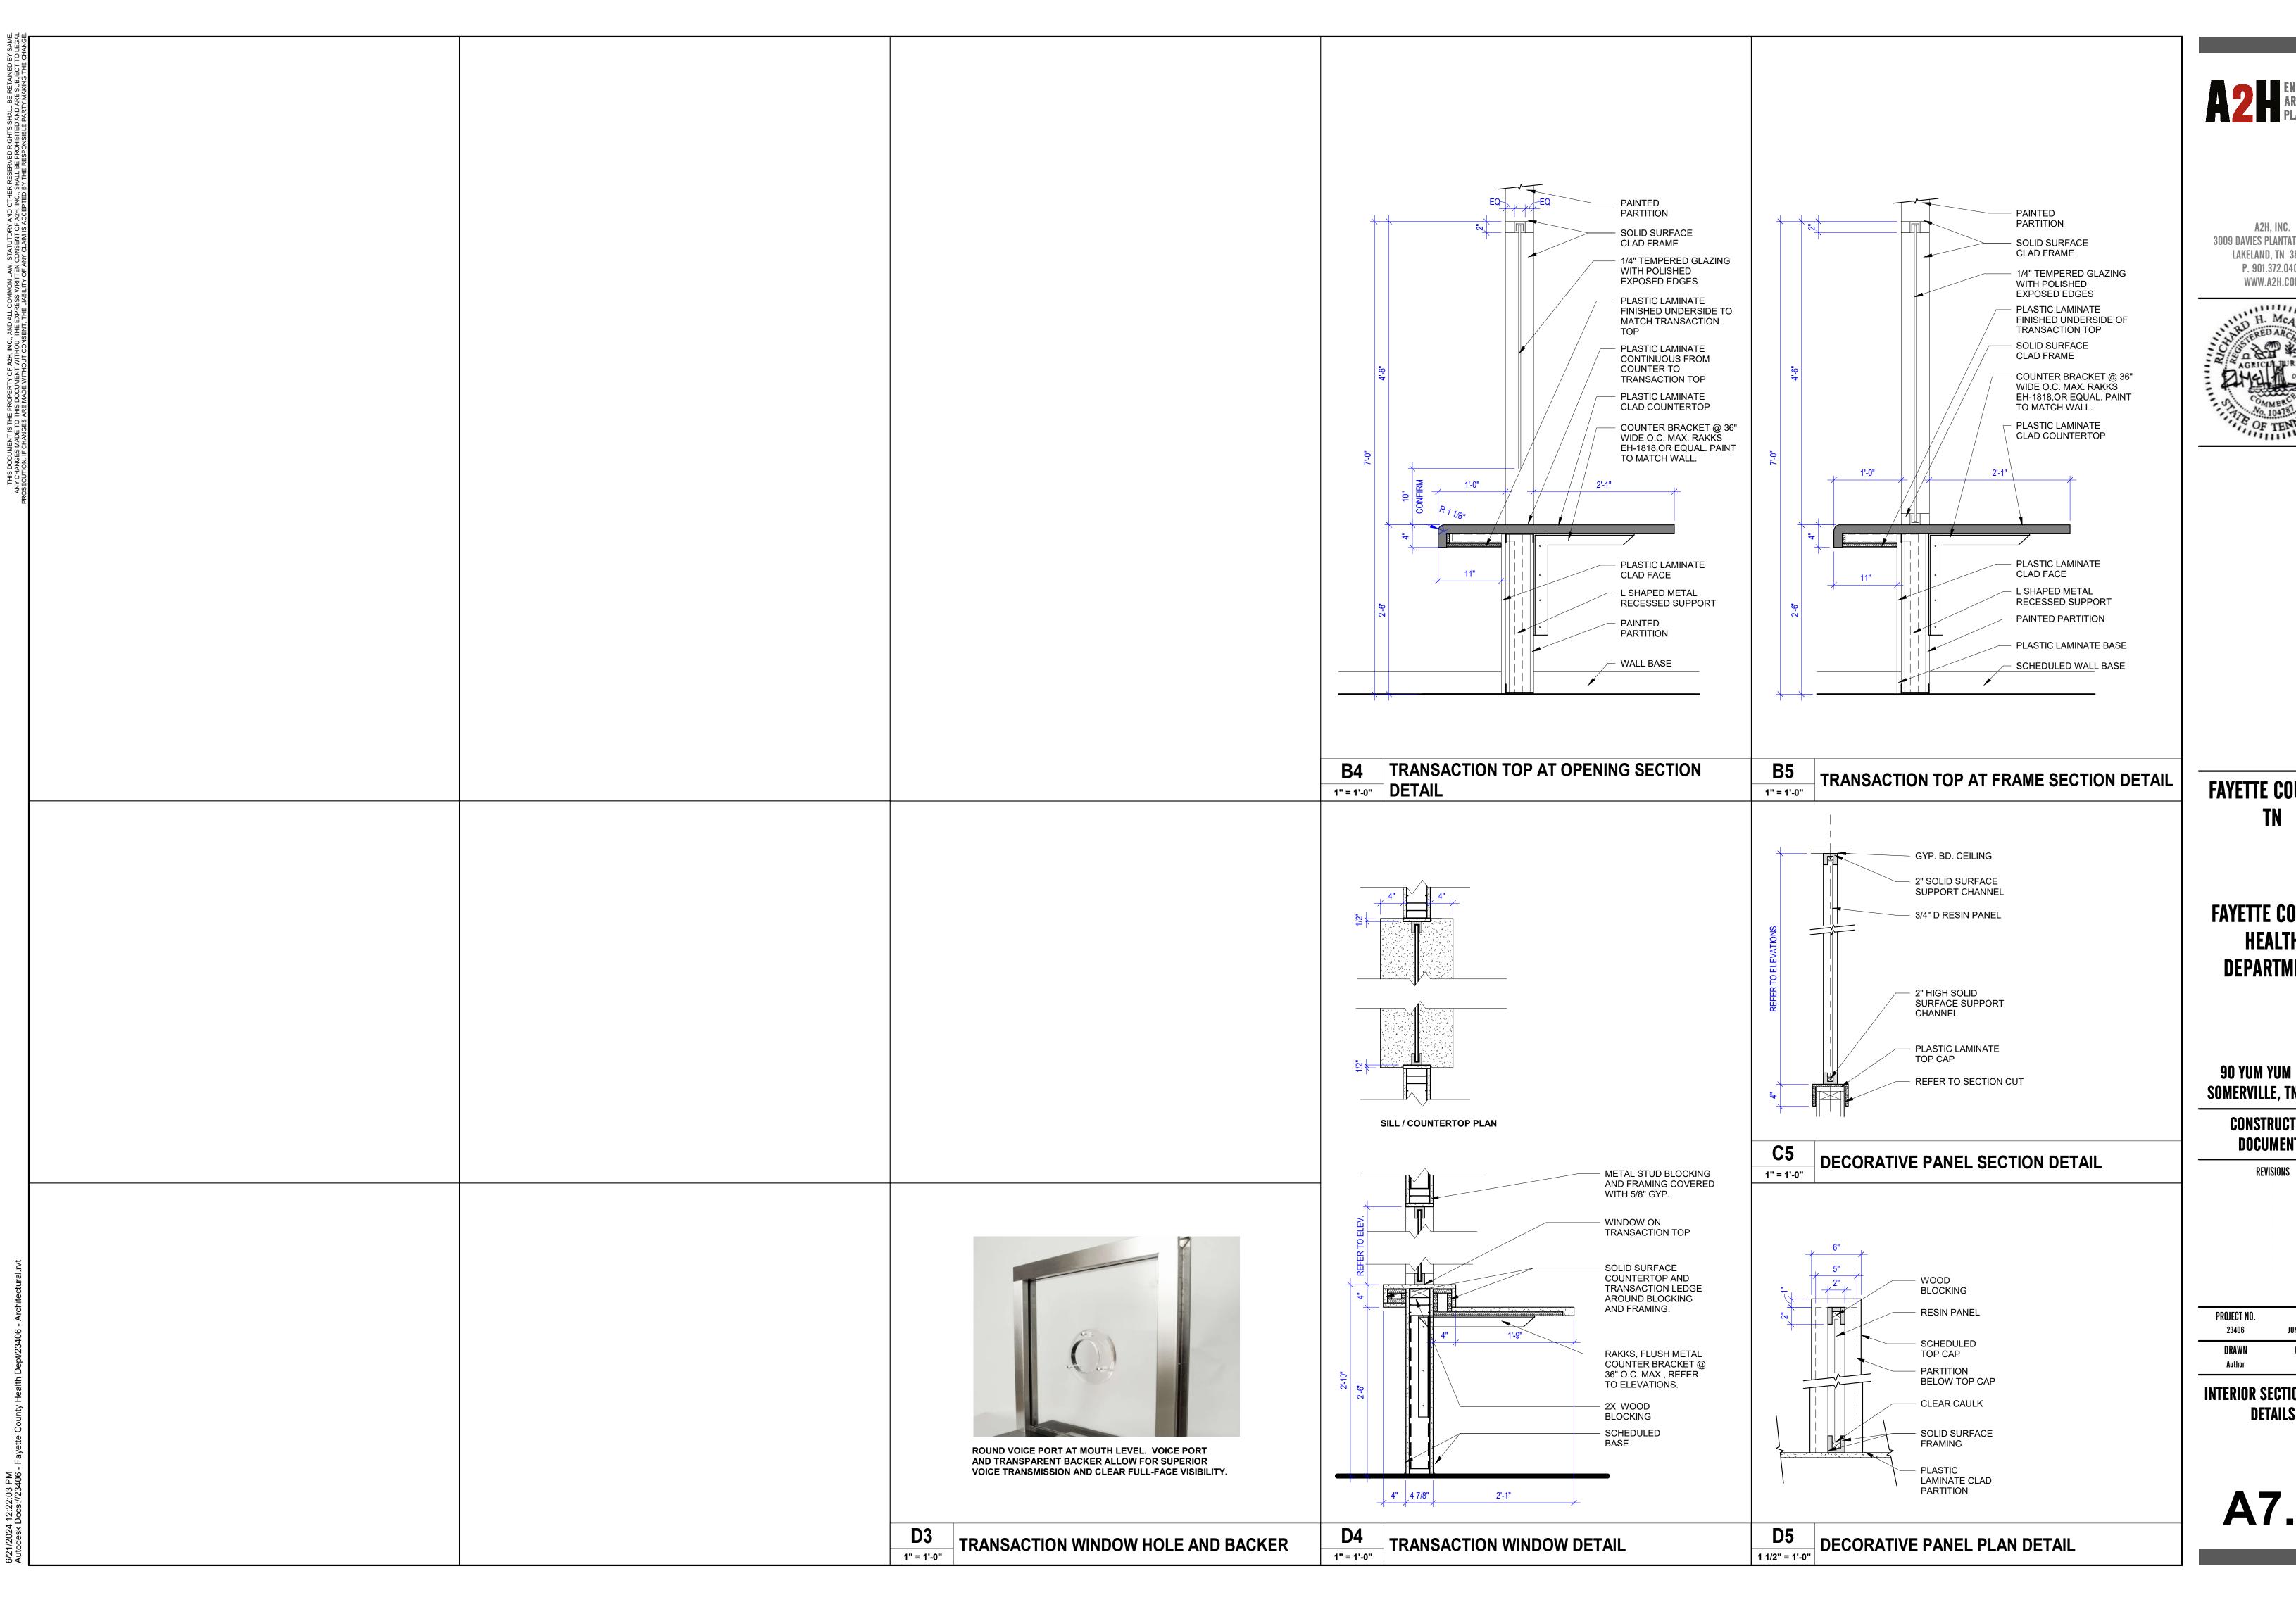



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FAYETTE COUNTY, TN


FAYETTE COUNTY HEALTH **DEPARTMENT**

90 YUM YUM ROAD SOMERVILLE, TN 38068

> CONSTRUCTION **DOCUMENTS**

PROJECT NO.	DATE
23406	June 20, 2024
DRAWN	CHECKED
Author	Checker

INTERIOR SECTIONS AND DETAILS

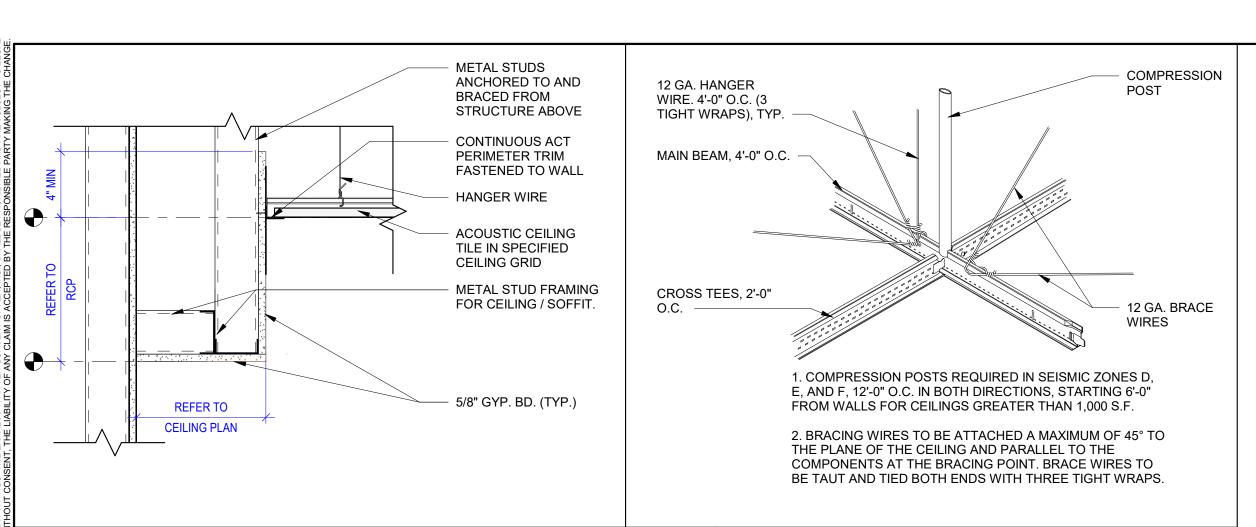

3" = 1'-0"

SEISMIC BRACING DETAIL

TYPE	DESCRIPTION / MODEL	EDGE PROFILE	SUSPENSION SYSTEM	COMMENT
A1	ARMSTRONG 1732 2X2	ANGLED TEGULAR 15/16	15/16 EXPOSED TEE	
A2	ARMSTRONG 1728 2X4	SQUARE LAY-IN 15/16	15/16 EXPOSED TEE	
G1	GYPSUM BOARD. SMOOTH. PAINTED	N/A	LIGHT GAGE METAL FRAMING @16" O.C. U.N.O.	PNT-1 U.N.O.

SHADED AREA NOT IN SCOPE U.N.O.

WALL LEGEND	
WALL LEGEND	
	DEMO WALL
	EXISTING WALL
	NEW WALL
	1 HOUR RATED BARRIER

2 HOUR RATED BARRIER

OFFICE


WOMEN

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WALL LEGEND - REMODEL N.T.S.


REFER TO FINISH SCHEDULE FOR EXCEPTIONS ON SHEET A7.2



CEILING SOFFIT DETAIL

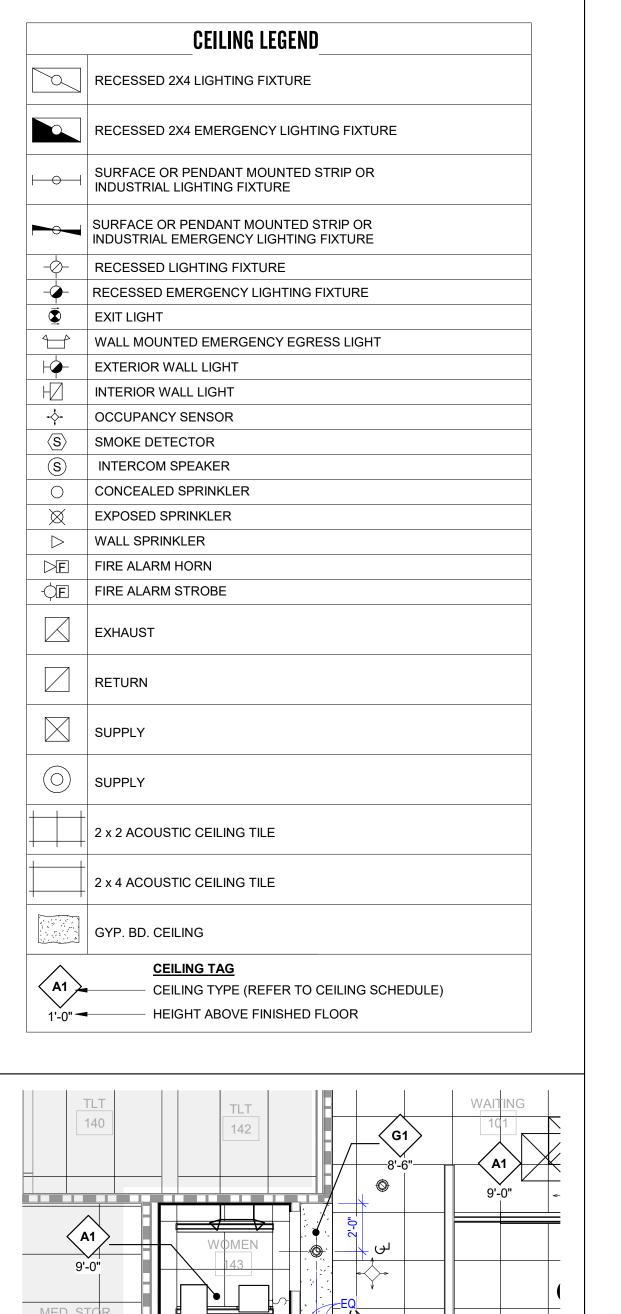1 1/2" = 1'-0"


1/4" = 1'-0"

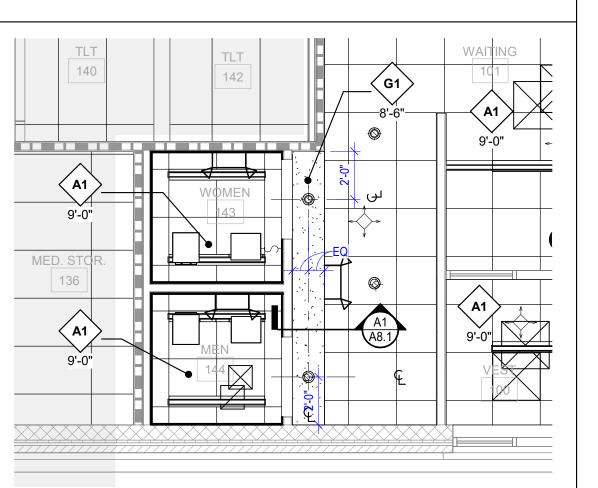

9-0" 136 A1 9-0" 143 A1 9-0" 144 A1 9-0" 144 A1 9-0"		
ENLARGED RCP - PUBLIC RESTROOMS	D2 3/16" = 1'-0"	

REFLECTED CEILING PLAN

134

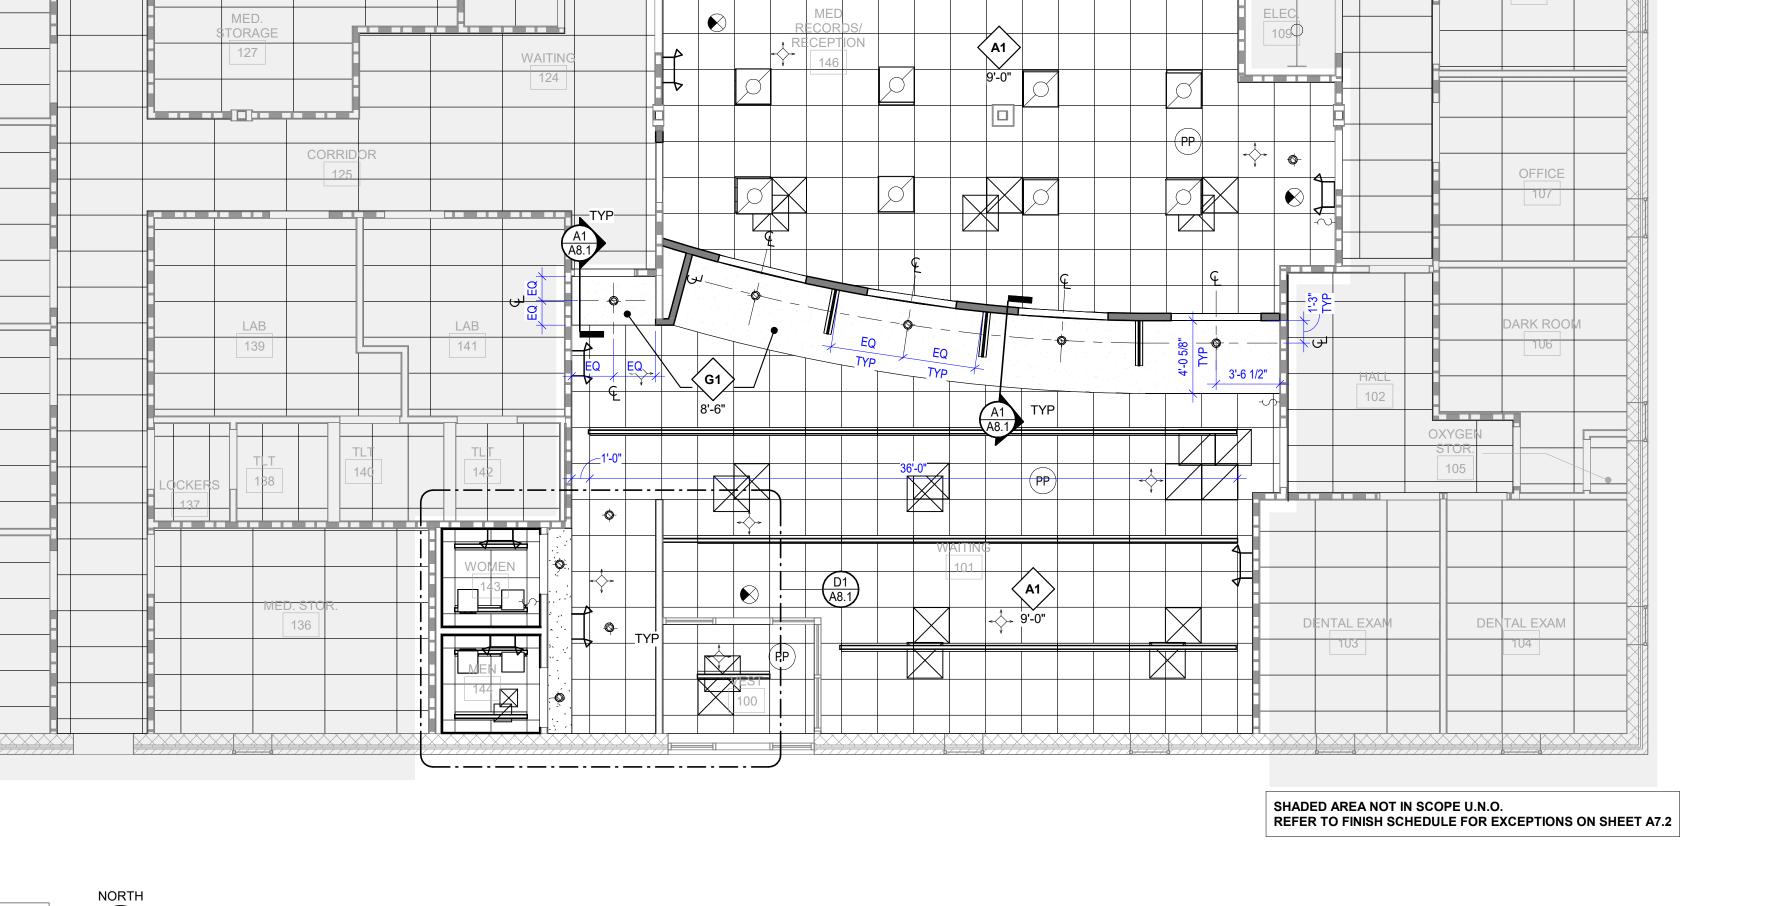

FAYETTE COUNTY,

FAYETTE COUNTY HEALTH **DEPARTMENT**


90 YUM YUM ROAD SOMERVILLE, TN 38068

> CONSTRUCTION **DOCUMENTS**

> > REVISIONS

PROJECT NO. DATE JUNE 20, 2024 CHECKED

REFLECTED CEILING PLAN

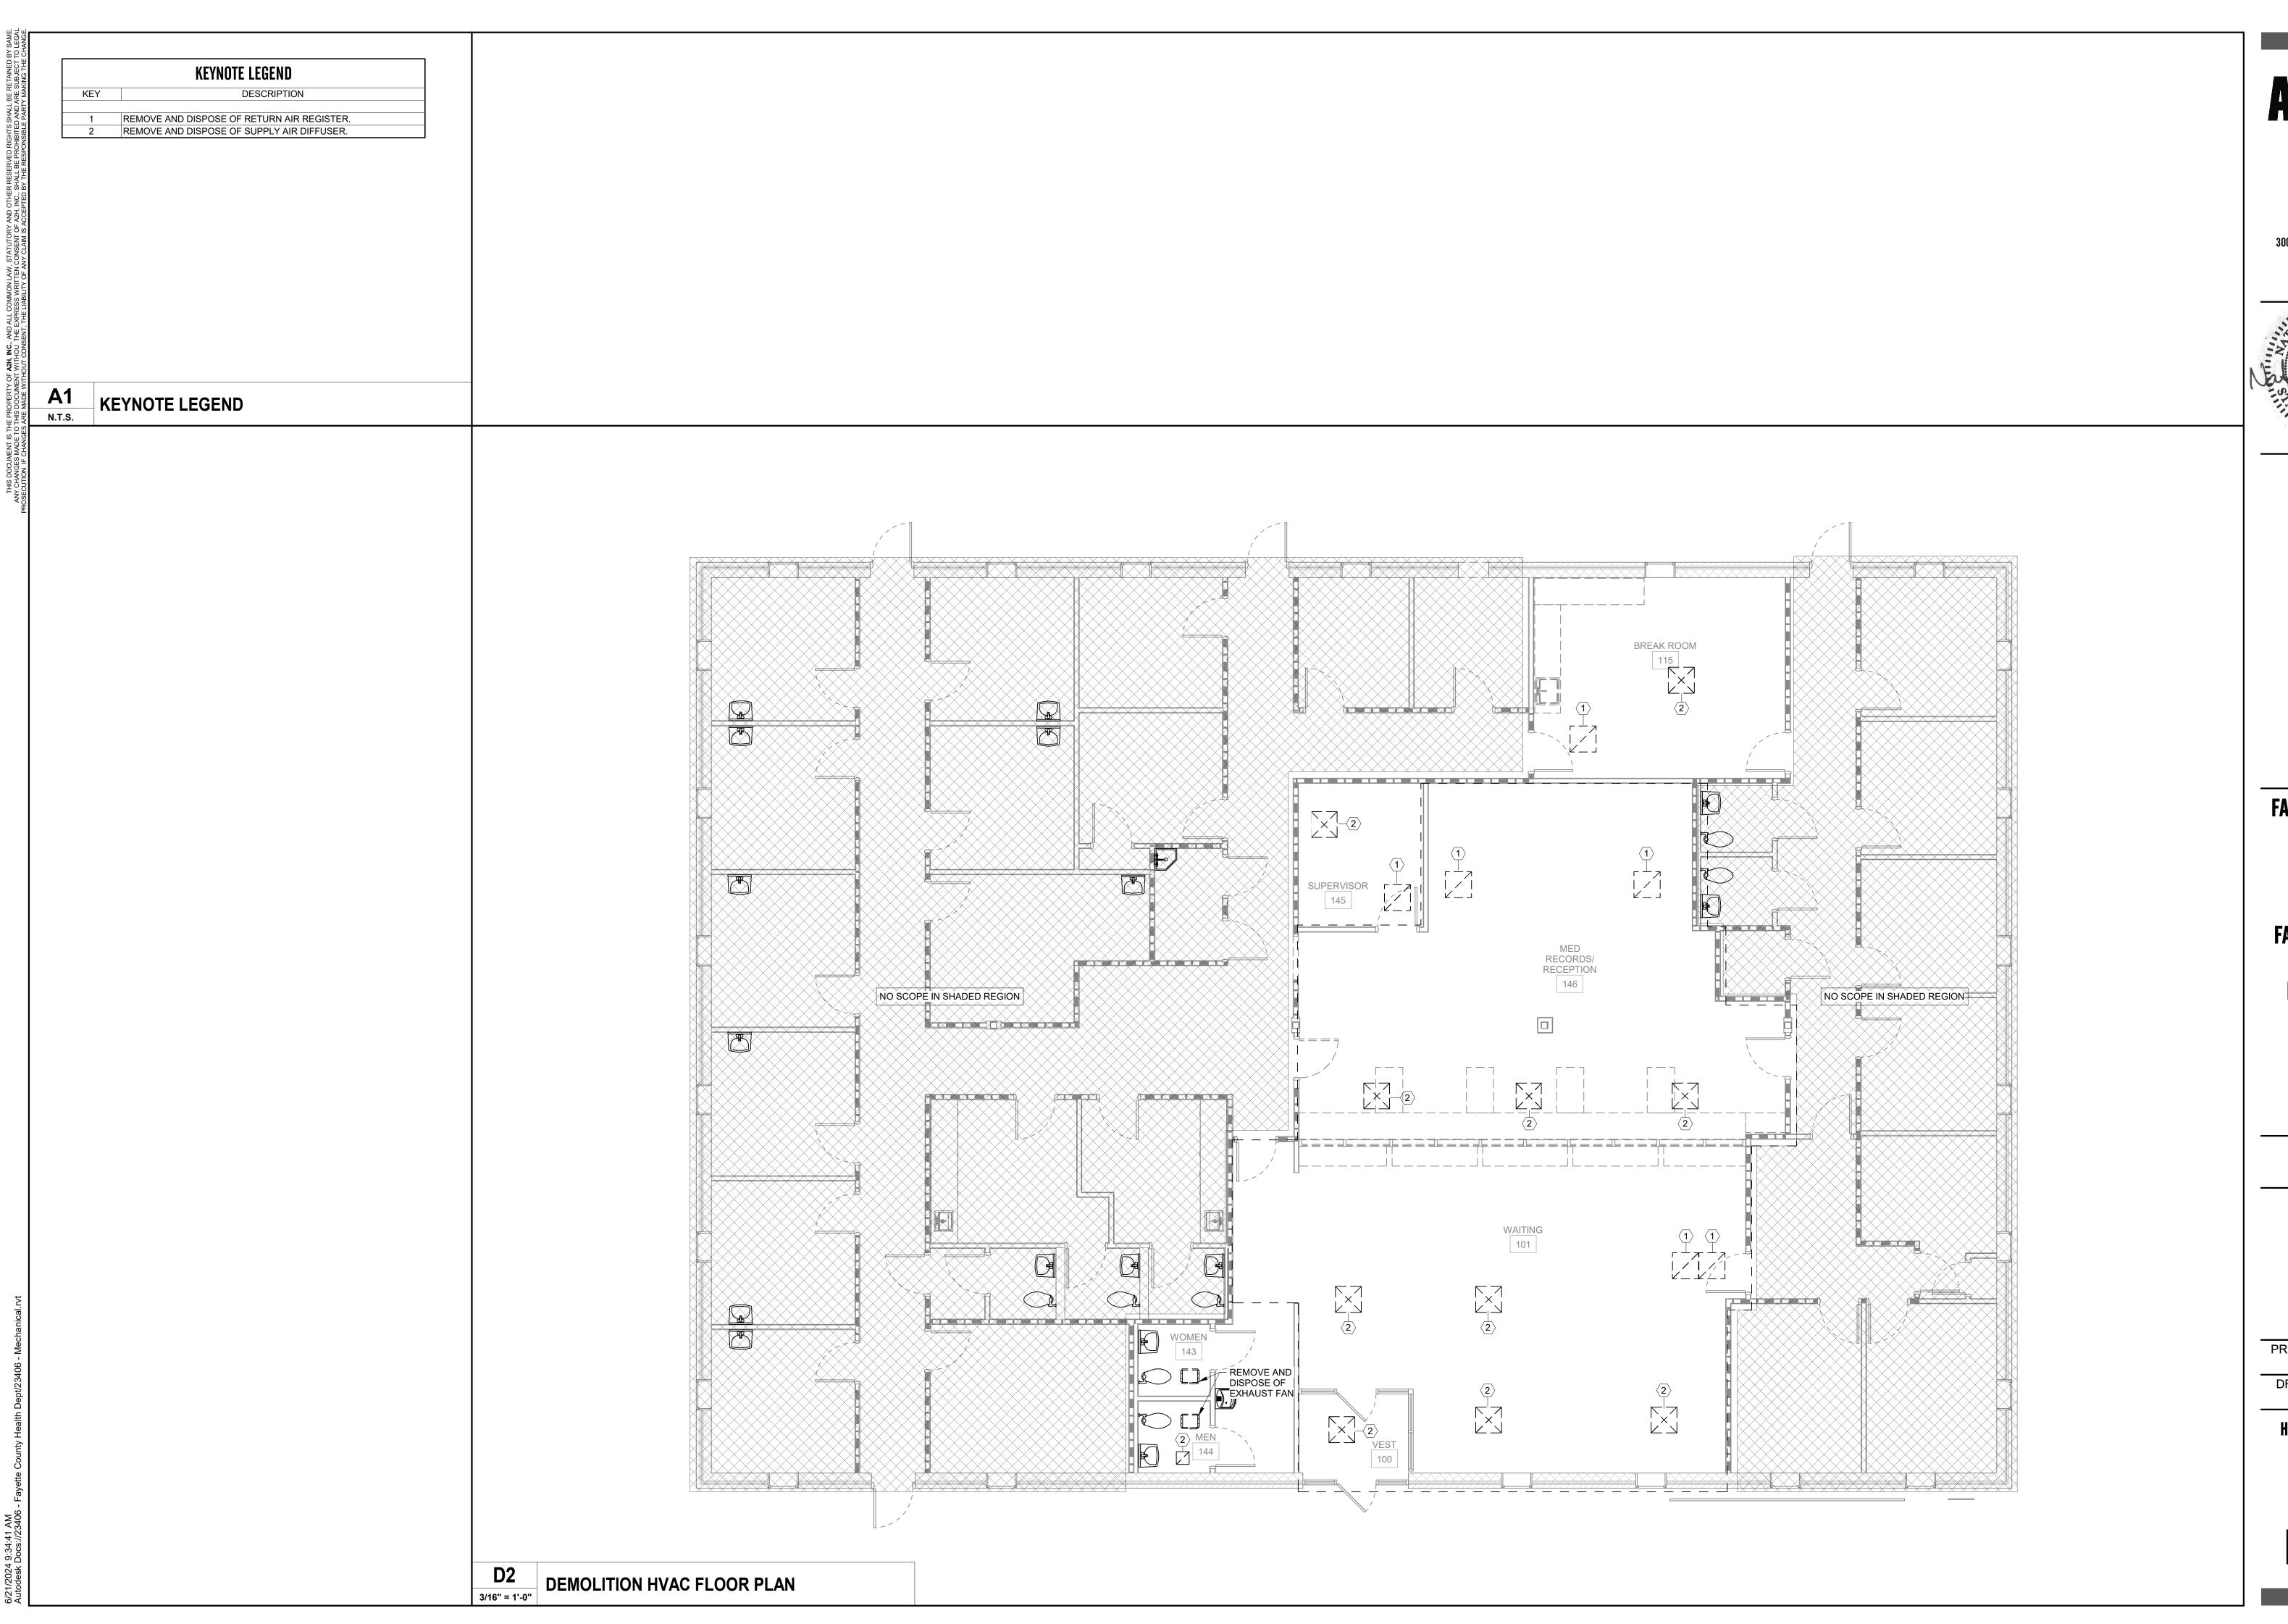

ENGINEERS ARCHITECTS PLANNERS

A2H, INC. 3009 davies plantation ro Lakeland, tn 38002 P. 901.372.0404 www.a2h.com



FAYETTE COUNTY, TN

FAYETTE COUNTY
HEALTH
DEPARTMENT

FAYETTE COUNTY

CONSTRUCTION DOCUMENTS

REVISIONS

PROJECT DATE

MOE. JUNE 20, 2024

DRAWN CHECKED


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HVAC FLOOR PLAN -Demolition


M0.1

- COORDINATE INSTALLATION OF DUCTWORK WITH OTHER DIVISIONS. ALL DUCTWORK ASSOCIATED WITH THE MECHANICAL SYSTEMS SHALL BE INSTALLED AND SECURED PER APPLICABLE BUILDING CODES. PROVIDE ACCESS PANELS FOR ALL MECHANICAL EQUIPMENT INSTALLED ABOVE HARD CEILINGS OR IN FURRED CHASES REQUIRING ACCESS, SUCH AS VOLUME DAMPERS, PIPING VALVES,
- MECHANICAL CONTRACTOR SHALL INSTALL VOLUME DAMPERS IN AIR DUCTS TO NEW SUPPLY, RETURN, AND EXHAUST GRILLES, AS APPLICABLE. VOLUME DAMPERS
- SHALL BE LOCATED FOR ACCESS FROM LAY-IN CEILINGS OR ACCESS DOORS. THERMOSTAT HEIGHT SHALL BE 4'-0" ABOVE FINISHED FLOOR AND SHALL BE ALIGNED WITH LIGHT SWITCH WHERE SHOWN AT THE SAME LOCATION. MANUAL BALANCING DAMPERS SHALL BE LOCATED WHERE OPERATORS ARE
- DUCT SIZES SHOWN ARE NET DIMENSIONS MEASURED FROM THE INSIDE (UNLESS OTHERWISE NOTED). PROVIDE FLEXIBLE CONNECTIONS TO DUCTWORK AT ALL INDOOR UNITS, AS
- APPLICABLE. COORDINATE EXACT LOCATION OF ALL PIPING AND DUCT PENETRATIONS OF WALLS
- WITH STRUCTURAL BRACING. WHERE PIPING IS ROUTED THROUGH EXTERIOR WALL OF BUILDING PROVIDE "LINK SEAL" AND SLEEVES FOR PENETRATION OF WALL.
- DUCT LOCATIONS THROUGH MASONRY PARTITIONS AND BEARING WALLS MUST BE COORDINATED WITH OTHER OPENINGS AND WALL REINFORCING REQUIREMENTS SO THAT STRENGTH OF WALL IS NOT IMPAIRED. EQUIPMENT AND APPLIANCES SHALL BE INSTALLED AS REQUIRED BY THE TERMS OF
- THEIR APPROVAL, IN ACCORDANCE WITH THE CONDITIONS OF THE LISTING, THE MANUFACTURER'S INSTALLATION INSTRUCTIONS, AND THE 2015 IMC. MANUFACTURER'S INSTALLATION INSTRUCTIONS SHALL BE AVAILABLE ON THE JOB SITE AT THE TIME OF INSPECTION PER 2015 IMC, SECTION 304.1. WHERE CONFLICTS EXIST BETWEEN THE DRAWINGS, 2015 IMC, AND THE CONDITIONS OF THE LISTING OR THE MANUFACTURER'S INSTALLATION INSTRUCTIONS, THE PROVISIONS OF 2015 IMC SHALL APPLY. WHERE A CODE PROVISION IS LESS RESTRICTIVE THAN THE CONDITIONS OF THE LISTING OF THE EQUIPMENT OR APPLIANCE THE MANUFACTURER'S INSTALLATION INSTRUCTIONS, THE CONDITIONS OF THE LISTING AND THE MANUFACTURER'S INSTALLATION INSTRUCTIONS SHALL APPLY. PERMITS SHALL BE APPLIED FOR BY A LICENSED MECHANICAL, GAS OR FIRE
- PROTECTION CONTRACTOR. PROTECTION OF HVAC SYSTEM DURING CONSTRUCTION: ALL HVAC EQUIPMENT SHALL BE PROTECTED FROM DUST AND OTHER PARTICULATE MATTER. ALL SITE AND/OR INSTALLED ABSORPTIVE MATERIALS SHALL BE PROTECTED FROM MOISTURE DAMAGE. ALL DUCT AND EQUIPMENT OPENINGS SHALL BE PROPERLY
- THE DRAWINGS ARE DIAGRAMMATIC AND SHOW GENERAL MECHANICAL LAYOUTS FOR BIDDING PURPOSES ONLY. DRAWINGS ARE NOT SHOP DRAWINGS. THE ABOVE CEILING SPACE IS LIMITED WITH MANY TRADES WORKING IN THE SAME AREA. WORK MUST BE COORDINATED IN DETAIL WITH OTHER TRADES AND EXISTING CONDITIONS TO AVOID CONFLICTS. IT IS THE RESPONSIBILITY OF THE MECHANICAL CONTRACTOR TO PREPARE DETAILED SHOP DRAWINGS, FIELD VERIFY ALL EXISTING CONDITIONS, CONFIRM SPACE ALLOCATIONS, AND COORDINATE WITH THE WORK OF OTHER TRADES. MINOR ADJUSTMENTS SHALL BE MADE TO NEW PIPE, DUCT, AND EQUIPMENT LOCATIONS AND SIZES TO MATCH ACTUAL FIELD CONDITIONS SUCH THAT COMPONENTS FIT ABOVE FINISHED CEILINGS IN THE AVAILABLE SPACE. FIELD VERIFY CONDITIONS AND DIMENSIONS, AS NEEDED, PRIOR TO PREPARING SHOP DRAWINGS, ORDERING EQUIPMENT, OR BEGINNING WORK. WHERE A CONFLICT WILL EXIST (FIT, FORM, OR FUNCTION), CONTRACTOR SHALL IMMEDIATELY NOTIFY DESIGN ENGINEER PRIOR TO PROCEEDING WITH WORK.
- EQUIPMENT AND APPLIANCES SHALL BE INSTALLED PER THE MANUFACTURER'S INSTALLATION INSTRUCTIONS, AND THESE INSTRUCTIONS MUST BE ON THE JOB SITE AT THE TIME OF INSPECTION. IMC 304.1
- A LICENSED MECHANICAL AND OR GAS CONTRACTOR SHALL OBTAIN A PERMIT(S) PRIOR TO COMMENCING ANY WORK FOR WHICH THE MECHANICAL OR GAS CODE REQUIRE A PERMIT.


HVAC GENERAL NOTES

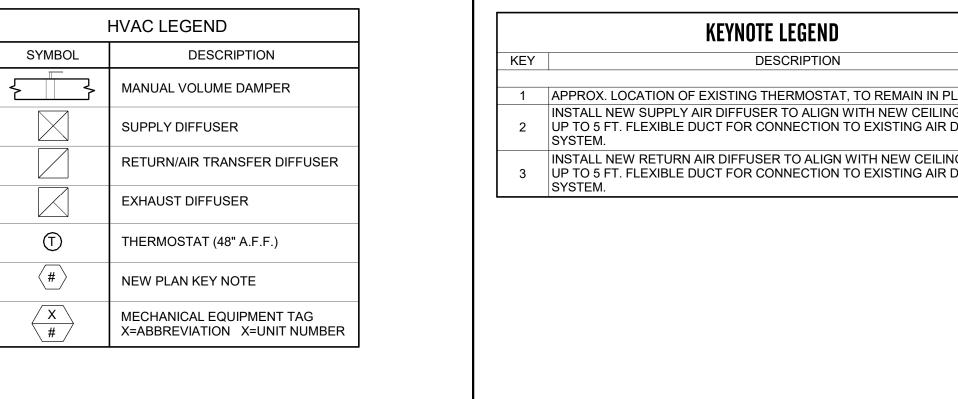


KEYNOTE LEGEND HVAC LEGEND N.T.S.

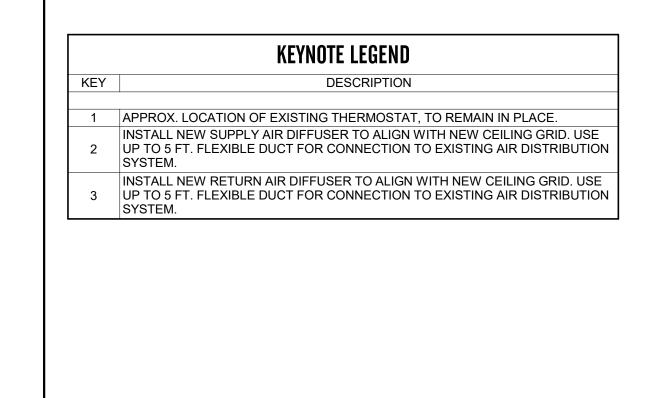

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<u>HVAC GENERAL NOTES</u>:

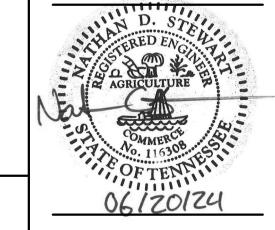1. CONTRACTOR SHALL REPLACE ALL FLEX DUCT REMOVED, IF NOT OTHERWISE

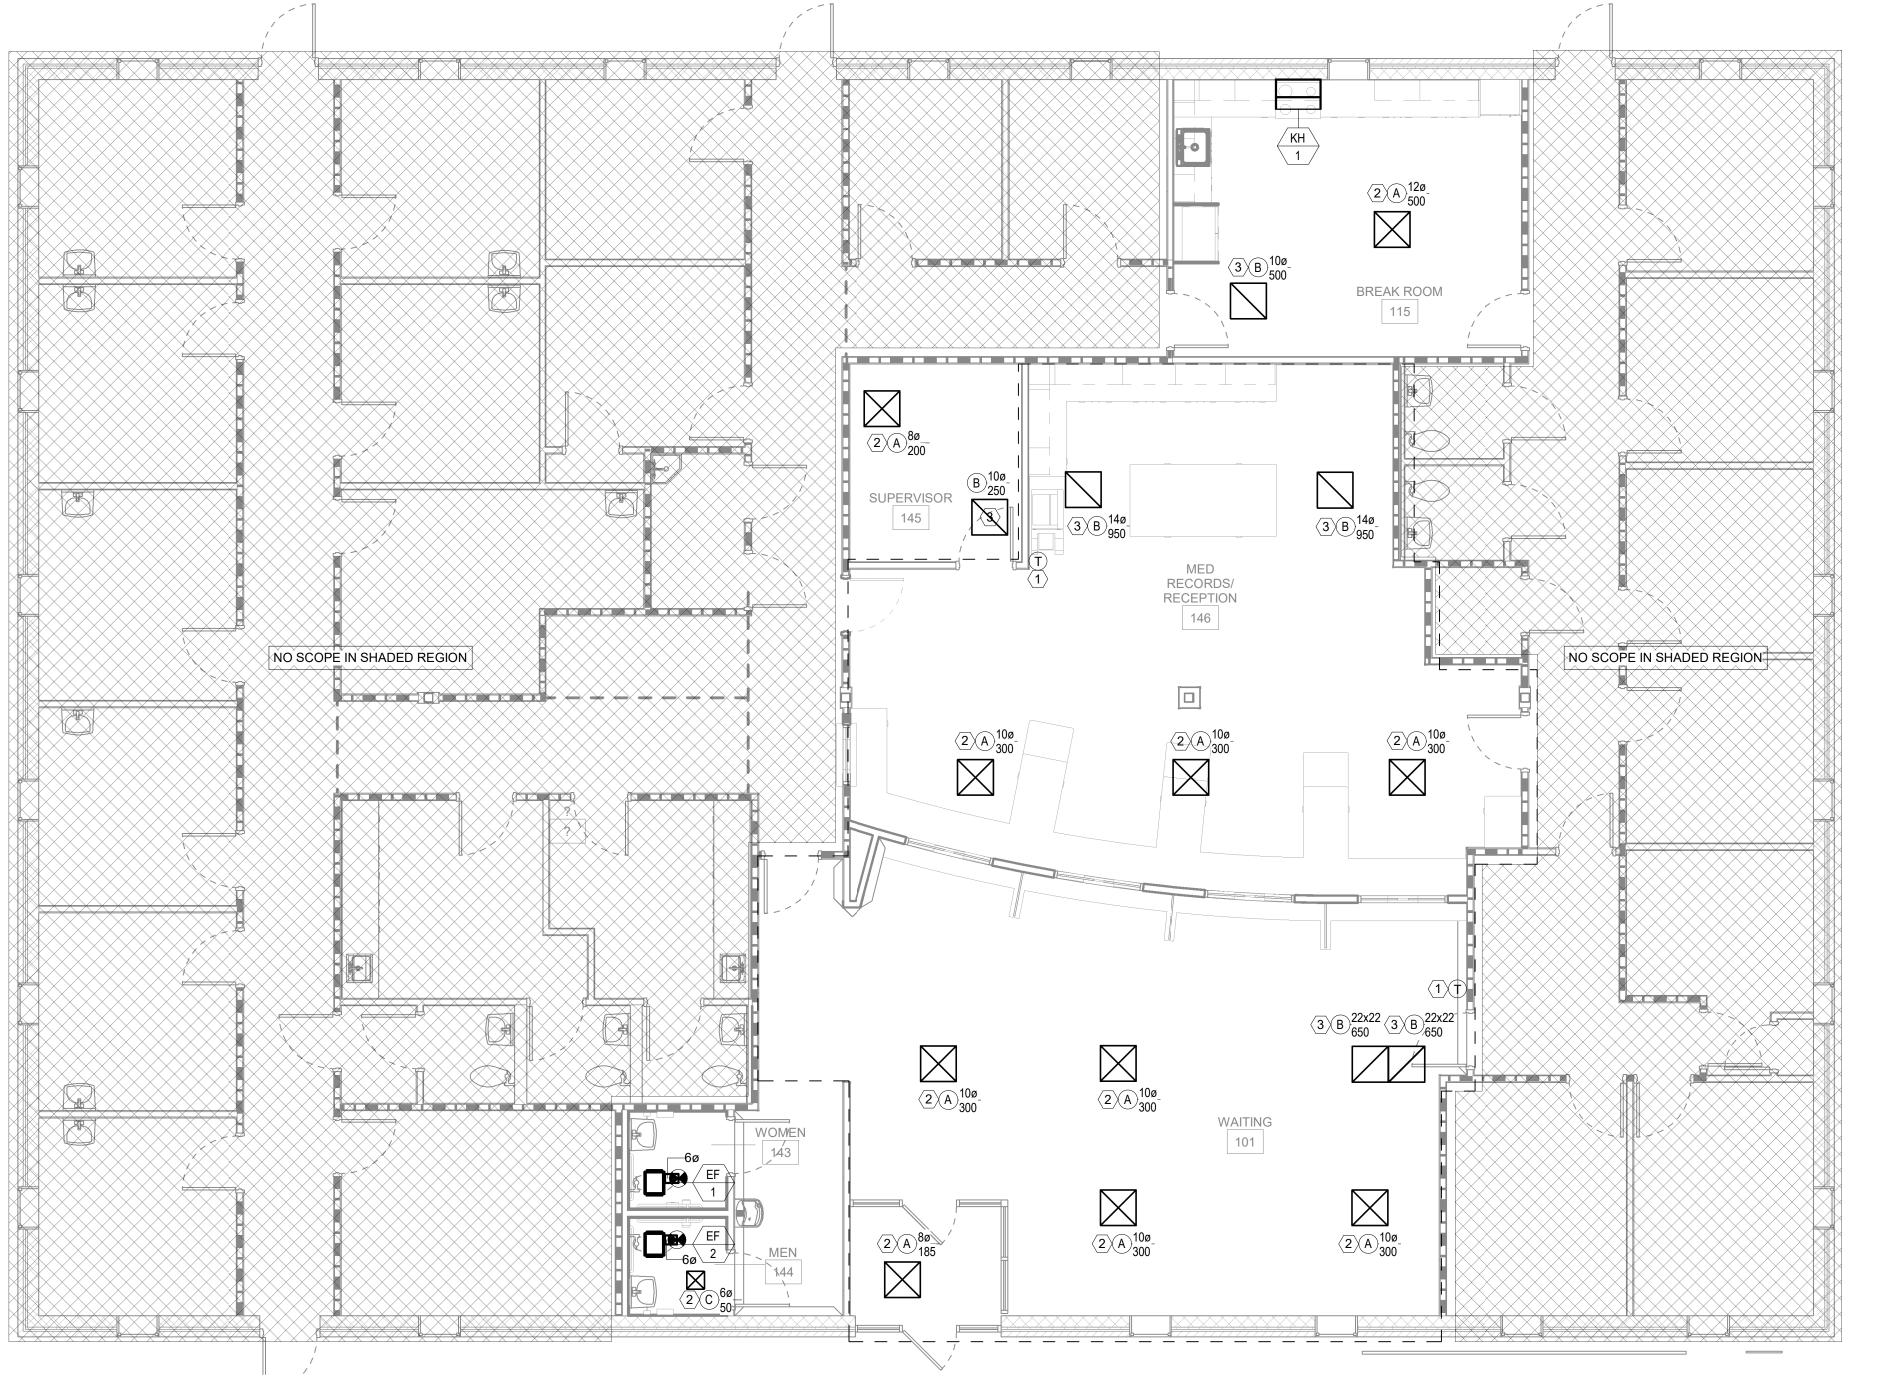NOTED AS CHANGED BELOW. 2. CONTRACTOR IS RESPONSIBLE FOR AND SHALL BALANCE DIFFUSERS TO AIRFLOWS AS SHOWN IN VIEW.

THESE DRAWINGS ARE DIAGRAMMATIC COORDINATION OF ALL TRADES AND COMPLIANCE WITH DIMENSIONS ON ARCHITECTURAL AND STRUCTURAL DRAWINGS ARE REQUIRED

FAYETTE COUNTY HEALTH **DEPARTMENT**

FAYETTE COUNTY

CONSTRUCTION **DOCUMENTS**

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CHECKED

HVAC FLOOR PLAN

3/16" = 1'-0"

N.T.S.

OVERALL HVAC FLOOR PLAN

1.01 RELATED DOCUMENTS

A. DRAWINGS AND THE GENERAL CONDITIONS, INSTRUCTIONS TO BIDDERS, AND ALL OTHER GENERAL REQUIREMENTS OF THESE SPECIFICATIONS SHALL BE CONSIDERED A COMPONENT OF THIS DIVISION OF THE SPECIFICATIONS.

B. THIS SECTION OF THE SPECIFICATIONS INCLUDES GENERAL PROVISIONS APPLICABLE TO ALL WORK OF DIVISION 23. C. THIS CONTRACTOR SHALL EXAMINE ALL OTHER DIVISIONS OF THE SPECIFICATIONS AND ALL DRAWINGS FOR THE PROJECT AND SHALL FAMILIARIZE HIMSELF WITH ALL FEATURES OF THE PROJECT THAT MAY AFFECT HIS WORK.

1.02 CONTRACT DOCUMENTS

. REFER TO AND COMPLY WITH OTHER SECTIONS OF THESE SPECIFICATIONS IN THE INSTALLATION OF ALL MECHANICAL WORK.

B. DRAWINGS ARE DIAGRAMMATIC: THEREFORE, ALL OFFSETS, FITTINGS, VALVES AND ACCESSORIES ARE NOT SHOWN. PLAN WORK AROUND BUILDING DETAILS AND OTHER CRAFTS

1.03 CODES, ORDINANCES, INSPECTIONS AND PERMITS

A. WORK IS TO BE EXECUTED AND INSPECTED IN ACCORDANCE WITH LOCAL AND STATE CODES, LAWS, ORDINANCES, RULES AND REGULATIONS APPLICABLE TO PARTICULAR CLASS

OF WORK, AND ANY FEES IN CONNECTION THEREWITH ARE TO BE PAID BY THE CONTRACTOR. B. ARRANGE WITH CITY, OR STATE IF CITY HAS NO ORDINANCES COVERING WORK, FOR COMPLETE INSPECTION, PAYING ALL CHARGES PERTAINING THERETO

1.04 SHOP DRAWINGS, SUBMITTALS AND SUBSTITUTIONS

A. SUBMIT WITHIN 30 DAYS AFTER NOTICE TO PROCEED, MANUFACTURER'S CATALOG SHEETS AND/OR SHOP DRAWINGS COVERING ALL PHASES OF WORK INCLUDED IN THIS

B. SUBMITTALS SHALL BE COMPLETE, ARRANGED IN SETS AND BOUND IN FOLDERS. NO LOOSE SHEETS OR PARTIAL SUBMITTALS WILL BE ACCEPTABLE.

C. SUBMITTALS ARE REQUIRED EVEN THOUGH EQUIPMENT BEING FURNISHED IS EXACTLY AS SPECIFIED.

D. FINAL DECISION AS TO WHETHER OR NOT A SPECIFIC PIECE OF EQUIPMENT MEETS SPECIFICATIONS SHALL REST WITH ARCHITECT-ENGINEER. E. SHOULD ANY PROPOSED SUBSTITUTION REQUIRE MODIFICATIONS TO THE ELECTRICAL SYSTEM (I.E., WIRE SIZES, DISCONNECTS, FUSES, ETC.), SUCH MODIFICATIONS SHALL BE COORDINATED WITH THE ELECTRICAL CONTRACTOR AND SHALL BE MADE TO THE COMPLETE SATISFACTION OF THE ARCHITECT-ENGINEER WITHOUT ADDITIONAL COST TO THE

1.05 WARRANTY AND OPERATION INSTRUCTIONS

PROVIDED BY OWNER AND/OR OWNER'S VENDOR.

A. ALL MATERIALS AND EQUIPMENT SHALL CARRY A FULL YEAR'S WARRANTY FROM TIME OWNER ACCEPTS BUILDING OR THE DATE OF SUBSTANTIAL COMPLETION, WHICHEVER IS

EARLIER, REGARDLESS OF START-UP DATE OF EQUIPMENT, UNLESS A LONGER WARRANTY PERIOD IS SPECIFIED UNDER OTHER PARAGRAPHS OF THIS SECTION. B. TURN OVER TO OWNER ALL OPERATION INSTRUCTIONS AND WARRANTIES FURNISHED WITH EQUIPMENT

1.06 EQUIPMENT CONNECTIONS

A. EACH EQUIPMENT ITEM, WITH DRAIN CONNECTIONS, SHALL BE PROVIDED WITH A PROPERLY SIZED DRAIN RUN TO THE NEAREST FLOOR DRAIN OR AS DIRECTED.

B. ROUGH-IN AND MAKE FINAL CONNECTION TO ALL EQUIPMENT FURNISHED UNDER OTHER DIVISIONS OF THESE SPECIFICATIONS OR BY THE OWNER. C. CONTRACTOR SHALL INSTALL ROUGH-INS ONLY AFTER HE HAS RECEIVED APPROVED SHOP DRAWINGS OR HAS OBTAINED DRAWINGS AND/OR SPECIFICATIONS FOR EQUIPMENT

1.07 FLASHINGS

A. ROOF FLASHINGS ARE TO BE FURNISHED AND INSTALLED UNDER THE ROOFING DIVISION OF THESE SPECIFICATIONS.

A. PROVIDE ALL CUTTING AND PATCHING REQUIRED TO PERFORM THE MECHANICAL WORK.

B. ALL PATCHING SHALL BE DONE BY WORKMEN SKILLED IN THE TRADE REQUIRED.

1.09 EXCAVATION, TRENCHING AND BACKFILLING

A. ALL EXCAVATION, TRENCHING AND BACKFILLING IN CONNECTION WITH THE MECHANICAL SYSTEM IS INCLUDED AS PART OF THIS DIVISION

B. ALL EXCAVATION REQUIRED SHALL BE DONE AS PART OF THE BID PRICE REGARDLESS OF ANY IMPLIED CONDITIONS ON THE PLANS OR IN THESE SPECIFICATIONS.

1.10 SUPPORTS & FOUNDATIONS

A. THE CONTRACTOR SHALL BE RESPONSIBLE FOR THE MISCELLANEOUS SUPPORTING SYSTEMS.

B. PROVIDE ADEQUATE PIPE, EQUIPMENT FOUNDATION AND SUSPENSION SYSTEMS IN ACCORDANCE WITH RECOGNIZED ENGINEERING PRACTICES.

C. PIPE HANGERS SHALL BE EQUAL TO THOSE MANUFACTURED BY B-LINE.

1.11 ELECTRICAL

A. FURNISH AND INSTALL ALL ELECTRICAL INTERLOCK AND CONTROL WIRING FOR PROPER OPERATION AND CONTROL OF ALL MECHANICAL EQUIPMENT

B. SUPERVISE AND COORDINATE ALL ELECTRICAL WORK IN CONNECTION WITH MECHANICAL SYSTEM. C. FURNISH ALL MOTOR CONTROLLERS OR CONTACTORS FOR PROPER OPERATION OF ALL MOTORS.

1.12 TESTING AND ADJUSTING

B. PERFORM OPERATIONAL TESTING OF HVAC EQUIPMENT AND BALANCING OF AIR DISTRIBUTION SYSTEM. BALANCING SHALL BE PERFORMED BY AN AGENCY CERTIFIED BY THE ASSOCIATED AIR BALANCE COUNCIL (AABC) OR BY THE NATIONAL ENVIRONMENTAL BALANCING BUREAU (NEBB). ALL WORK SHALL BE BY QUALIFIED TECHNICIANS UNDER DIRECT SUPERVISION OF A CERTIFIED TEST AND BÁLANCE ENGINEER. PROVIDE A FINAL TEST AND BALANCE REPORT TÁBULATING RESULTS OF AIR BALANCE. DIFFUSERS SHALL BE BALANCED TO WITHIN 10 PER CENT OF DESIGN REQUIREMENTS.

C. OPERATE ALL HVAC EQUIPMENT FOR A SUFFICIENT PERIOD OF TIME TO DEMONSTRATE THAT IT IS OPERATING PROPERLY. D. CONTRACTOR WILL BE REQUIRED TO MAKE ADJUSTMENT AS NECESSARY DURING THE FIRST YEAR.

PART 2 - HVAC

2.01 EQUIPMENT

A. EQUIPMENT SHALL BE EQUAL TO THAT SCHEDULED ON THE DRAWINGS.

B. ALL EXPOSED ROTATING MACHINERY SHALL BE EQUIPPED WITH GUARDS. C. ALL REFRIGERATION COMPRESSORS SHALL CARRY AN ADDITIONAL FOUR-YEAR WARRANTY

2.02 PIPING

A. REFRIGERANT: TYPE "K" COPPER WITH WROUGHT COPPER FITTINGS FOR REFRIGERANT USE. PRE-CHARGED LINES MAY BE USED.

B. CONDENSATE DRAIN: TYPE "L" OR "DWV" COPPER. SCHEDULE 40 PVC MAY BE USED, UNLESS DRAIN LINE IS LOCATED WITHIN A RETURN AIR PLENUM. C. NATURAL GAS: SCHEDULE 40 BLACK STEEL WITH MALLEABLE IRON OR WELDING FITTINGS. ALL CONCEALED AND BELOW GRADE PIPE SHALL BE WELDED. PIPE BELOW GRADE

SHALL BE COATED AND WRAPPED AND SHALL HAVE CATHODIC PROTECTION.

A. DUCTWORK: OWENS-CORNING, 2" THICK FIBERGLASS FACED DUCT WRAP TYPE 100 WITH FACTORY APPLIED FLAME-RETARDANT FOIL-REINFORCED KRAFT-FACING. (DUCTWORK

SHALL BE WRAPPED UNLESS SHOWN OTHERWISE.) B. DUCT LINER SHALL BE EQUAL TO OWENS-CORNING FIBERGLASS AEROFLEX TYPE 200, 2" THICK. DUCT SIZES SHOWN ARE SHEET METAL SIZES.

2.05 SHEET METAL

2.04 INSULATION

A. SHEET METAL DUCTWORK SHALL BE INSTALLED IN ACCORDANCE WITH ASHRAE HANDBOOK AND SMACNA HVAC DUCT CONSTRUCTION STANDARDS.

B. DUCTWORK SHALL BE NEW, PRIME QUALITY, GALVANIZED STEEL. RUNOUTS TO DIFFUSERS MAY BE MADE USING FACTORY INSULATED FLEXIBLE DUCTING. INSULATION SHALL BE ONE INCH MINIMUM THICKNESS GLASS FIBER FLEXIBLE BLANKET TYPE, WITH SUITABLE VAPOR BARRIER. FLEXIBLE DUCT SHALL BE UL LISTED CLASS 1 CONNECTOR OR AIR DUCT MATERIAL, STANDARD 181 WITH MANUFACTURER'S PRESSURE RATING OF AT LEAST 150 PERCENT OF THE MAXIMUM OPERATING PRESSURE OF THE SYSTEM INVOLVED. MAXIMUM LENGTH SHALL BE THREE FEET.

C. PROVIDE FLEXIBLE CONNECTIONS AT EACH AIR-HANDLING DEVICE WITH FAN.

PROVIDE ADEQUATE DAMPERS SO THAT THE DAMPERS AT THE GRILLES ARE NOT REQUIRED TO BALANCE THE SYSTEM.

GRILLES, DIFFUSERS AND REGISTERS SHALL BE EQUAL TO THOSE SHOWN ON THE DRAWINGS. FURNISH ACCESS DOORS TO FACILITATE MAINTENANCE OF SMOKE DETECTORS AND ACCESS TO BALANCING DAMPERS LOCATED ABOVE CEILINGS. ACCESS DOORS SHALL BE EQUAL TO MILCOR OR BOICO, STEEL OR ALUMINUM ASSEMBLIES, WITH HINGED DOORS, LOCKING CATCHES, AND SUITABLE FRAMES TO ACCOMMODATE BUILDING CONSTRUCTION INVOLVED, SIZES AS REQUIRED, BUT NOT SMALLER THAN 12 X 12 INCHES. ACCESS DOORS SHALL BE FACTORY-FINISH PAINTED TO MATCH COLOR OF BUILDING CONSTRUCTION

2.06 CONTROLS

INVOLVED.

A. PROVIDE ALL TEMPERATURE CONTROLS IN ACCORDANCE WITH RECOMMENDATIONS OF THE EQUIPMENT MANUFACTURER.

B. CONTROLS SHALL BE ELECTRIC TYPE C. PROVIDE ALL WIRING, ETC. REQUIRED FOR COMPLETE AND OPERATING SYSTEM.

D. FURNISH COMPLETE WIRING DIAGRAMS SHOWING ALL INTERLOCK WIRING IN ADDITION TO TEMPERATURE CONTROL WIRING DIAGRAMS. WIRING IS TO BE COLOR-CODED AND INSTALLED IN ACCORDANCE WITH NEC.

END OF SECTION 23 00 00

HVAC SPECIFICATIONS

FAN SCHEDULE S.P. IN. FAN MARK No. DRIVE MAX **MANUFACTUR** W.G. RPM TYPE SONES ELECTRICAL INTERLOCK ER MODEL NO. OPENING ACCESSORIES EF 1 DIRECT DRIVE BATTHROOM EXHAUST FAN 75 CFM 0.15 900 DIRECT 0.6 0.01 115/60/1 LIGHT SWITCH GREENHECK SP-B80 14 IN. x 12 IN. 2,7,13 EF 2 DIRECT DRIVE BATTHROOM EXHAUST FAN 75 CFM 0.15 900 DIRECT 0.6 0.01 115/60/1 LIGHT SWITCH GREENHECK SP-B80 14 IN. x 12 IN. 2,7,13

ACCESS DOOR FOR INSPECTION **ELECTRICAL DISCONNECT SWITCH**

BELT GUARD AND MOTOR GUARD ADJUSTABLE SHEAVES WALL SWITCH W/ PILOT LIGHT

MANUFACTURER'S PREFABRICATED INSULATED ROOF CURB (SLOPE AS REQUIRED) **ROOF JACK**

WALL JACK

BRICK VENT

SOFFIT GRILLE ROOF CAP W/ CURB

MOTORIZED BACKDRAFT DAMPER (SAME VOLTAGE AS FAN MOTOR OR W/ TRANSFORMER)

GRAVITY BACKDRAFT DAMPER

SOLID STATE SPEED CONTROLLER EXTENDED BASE WITH ACCESS DOOR(NO VENTS) FOR 40" MIN. DISCHARGE HEIGHT MOTOR AND DRIVE COMPARTMENT WEATHER HOOD

DRAIN CONNECTION HINGED ACCESS DOORS

WALL HOUSING GUARD 20. DAMPER GUARD AND WALL MOUNT HOUSING

FAN SCHEDULE N.T.S.

AIR DISTRIBUTION SCHEDULE GREENHECK TYPE O.B.V.D. FACE SIZE MODEL No. No | 24 IN. x 24 IN. | XG-7500 | PERFORATED, PATTERN CONTROLLERS CEILING DIFFUSER No 24 IN. x 24 IN. XG-7600R PERFORATED FACE CEILING RETURN GRILLE C No 12 IN. x 12 IN. XG-7500 PERFORATED, PATTERN CONTROLLERS CEILING DIFFUSER

COORDINATE AIR DISTRIBUTION DEVICE LOCATION WITH LIGHTS AND REFLECTED CEILING PLANS.

DIFFUSER SHOWN IS NEAREST MATCH TO EXISTING. CONTRACTOR SHALL VERIFY TYPE AND COLOR FOR BEST MATCH PRIOR TO

CEILING DEVICES SHALL BE COMPATIBLE WITH CEILINGS SPECIFIED

EQUAL DEVICES BY PRICE, KRUEGER, AND TITUS ARE ACCEPTABLE

DEVICE TYPE DIFFUSER CALLOUT

AIR DISTRIBUTION SCHEDULE N.T.S.

		KI	TCHEN RANG	GE HOOD S	CHEDULE		
UNIT	NO.	DIMENICIONI (L) M LI)) // m lm // l l m	BREAKER	OPERATING	MANUEACTURER	MODEL NO
MARK		DIMENSION (L x W x H)	V/ph/Hz	SIZE	CURRENT (A)	MANUFACTURER	MODEL NO.
KH	1	30 IN. x 19.25 IN. x 7 IN.	120/1/60	15	1.2	DENLAR	DS-30-F

N.T.S.

N.T.S.

1. PROVIDE WITH ADA ACCESSIBLE CONTROL BOX AND ALL NECESSARY ACCESSORIES TO COMPLY WITH APPLICABLE NFPA CODES.

2. PROVIDE OWNER WITH A NEW REPLACEMENT SET OF THE FOLLOWING FOR INSTALLATION


AFTER AN ACTUATION:

(1) DENLAR MODEL FUSIBLE LINK

(1) DENLAR MODEL TEST TANK (1) DENLAR MODEL REPLACEMENT TANK

(1) DENLAR MODEL TEST LINK


KITCHEN RANGE HOOD SCHEDULE

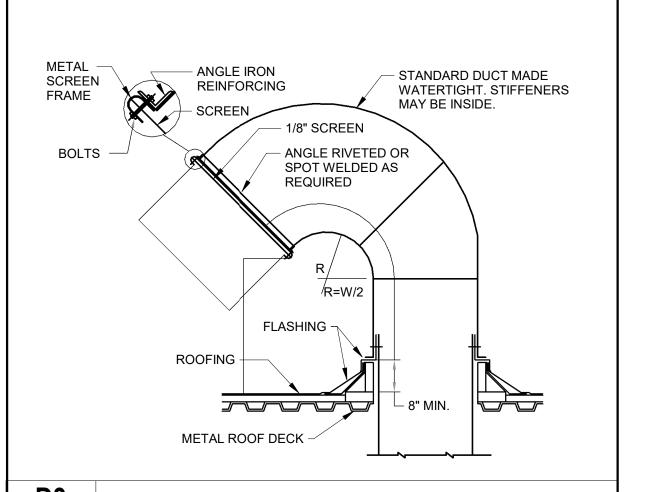

GOOSENECK DETAIL: FLAT ROOF

ROUND OR RECTANGULAR DUCT AS SHOWN ON INSULATED FLEXIBLE (6'-0" MAX LENGTH) SEE INSULATION SPEC FOR DIFFUSER BACKPAN **HANGER** REQUIREMENTS (TYP) TRANSITION -AS REQUIRED CEILING-REFER TO -REFLECTED CEILING PLANS FOR CEILING SUPPLY DIFFUSER TYPE AND DIFFUSER LOCATION


TYPICAL CEILING DIFFUSER DETAIL N.T.S.

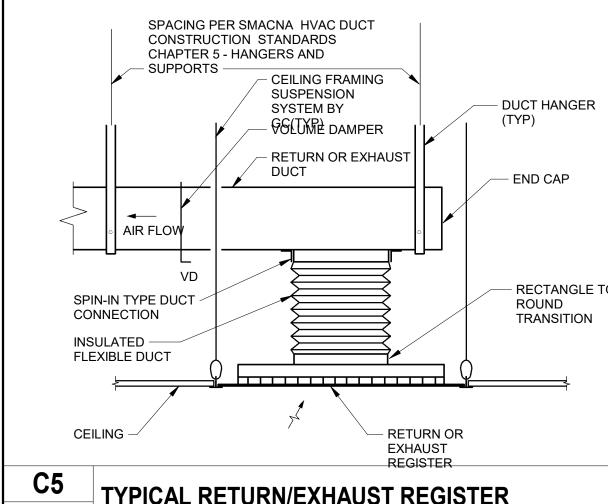

TYPICAL RETURN/EXHAUST REGISTER N.T.S.

P. 901.372.0404 WWW.A2H.COM

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FAYETTE COUNTY
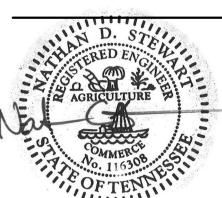
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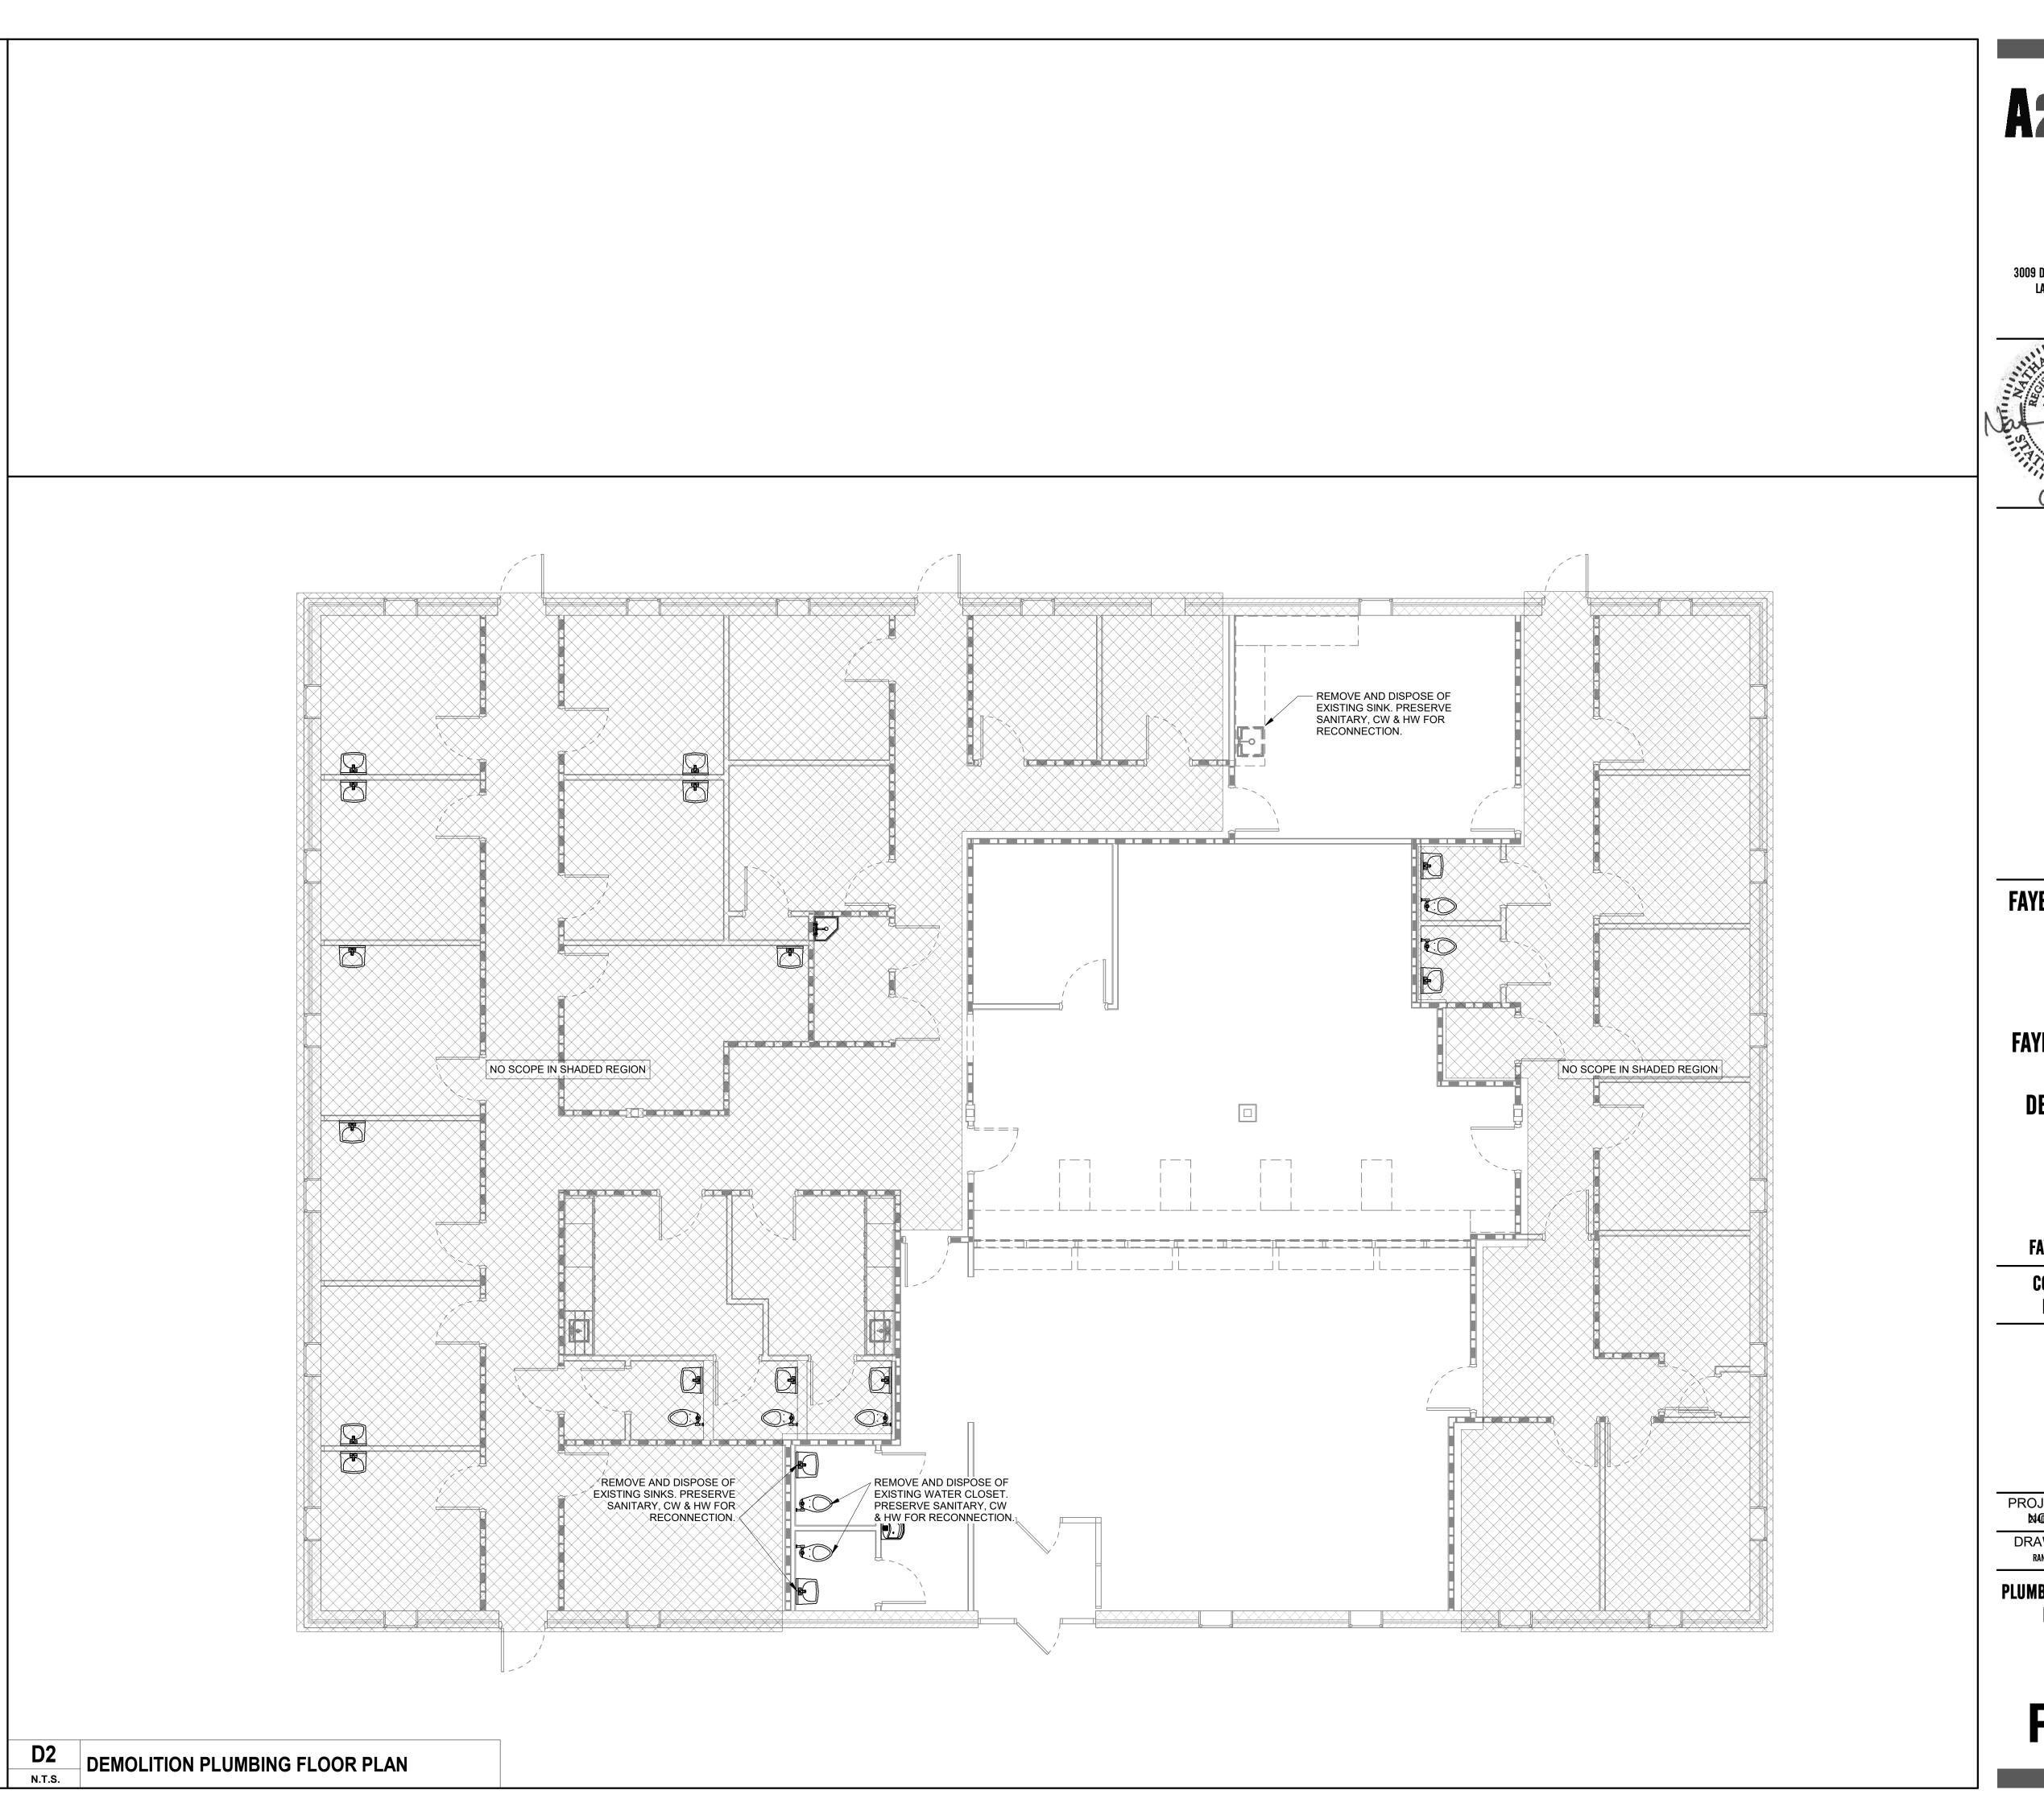
DOCUMENTS REVISIONS

CONSTRUCTION

PROJECT DATE JUNE 20, 2024 DRAWN CHECKED


HVAC SCHEDULES & DETAILS

N.T.S.



2 H ENGINEERS ARCHITECTS PLANNERS

AZH, INC. 3009 DAVIES PLANTATION R Lakeland, TN 38002 P. 901.372.0404 WWW.A2H.COM

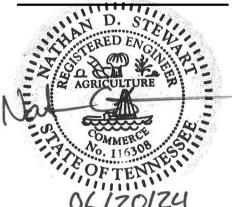

FAYETTE COUNTY, TN

FAYETTE COUNTY
HEALTH
DEPARTMENT

FAYETTE COUNTY

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PLUMBING FLOOR PLAN - DEMOLITION

P1.0

ALL WORK SHALL CONFORM TO THE LOCAL PLUMBING CODE, LOCAL BUILDING CODES, AND STATE HEALTH REGULATIONS HAVING JURISDICTION. ALL HAND LAVS DESIGNATED AS HANDICAPPED WITH EXPOSED PIPING SHALL BE PROVIDED WITH INSULATION KITS COVERING SINK DRAINS AND SINK SUPPLIES. PLUMBING CONTRACTOR SHALL REVIEW ARCHITECTURAL, STRUCTURAL, ELECTRICAL,

AND MECHANICAL DRAWINGS AND COORDINATE their WORK WITH ALL OTHER TRADES FOR PIPE ROUTING AND EQUIPMENT PLACEMENT. AVOID INTERFERENCE WITH ARCHITECTURAL FEATURES, BEAMS, FOOTINGS, WINDOWS, NOTIFY ARCHITECT OF ANY CONFLICTS. CONTRACTOR MAY RE-ROUTE PLUMBING TO AVOID CONFLICT WITH OTHER TRADES AFTER FIRST RECEIVING THE APPROVAL OF THE ARCHITECT / ENGINEER.

PLUMBING CONTRACTOR SHALL COORDINATE WITH ELECTRICAL CONTRACTOR ALL

VOLTAGES, ELECTRICAL LOADS, ETC. OF ELECTRICALLY OPERATED EQUIPMENT PRIOR

TO ORDERING. ALL WIRING BY ELECTRICAL CONTRACTOR. PLUMBING CONTRACTOR SHALL FURNISH ACCESS PANELS TO BE INSTALLED BY GENERAL CONTRACTOR AS REQUIRED FOR PLUMBING INSTALLATIONS.

ALL VALVES AND SHOKSTOPS SHALL BE ACCESSIBLE. PROVIDE AIR CUSHIONS FOR ALL FIXTURES THAT DO NOT HAVE SHOKSTOPS. . SLEEVES SHALL BE INSTALLED WHERE PIPING PASSES THROUGH STRUCTURE.

12. ALL PENETRATIONS THRU RATED WALLS OR FLOORS SHALL BE SEALED WITH AN APPROVED U.L. LISTED FIREPROOFING TO MAINTAIN THE INTEGRITY OF THE WALL OR 3. PIPE VIBRATION AND/OR PIPE SWAY WILL NOT BE PERMITTED.

 PROVIDE SUITABLE BACKING AND SUPPORT FOR ALL PLUMBING FIXTURES. OFFSET ALL V.T.R.'S AS REQUIRED WHETHER OR NOT SHOWN ON DRAWINGS.

16. ALL V.T.R.'S SHALL BE A MINIMUM OF 15 FT. AND/OR AS REQUIRED BY CODE AWAY FROM A/C INTAKES WHETHER OR NOT SHOWN ON PLANS. 7. ALL PIPING SHALL BE LABELED. 8. UPON COMPLETION OF WORK COVERED BY THIS CONTRACT, FURNISH THE OWNER

WITH ONE (1) SET OF REPRODUCIBLE "AS-BUILT" DRAWINGS WHICH SHOW ALL PLUMBING INSTALLED UNDER THIS CONTRACT. 9. ALL WATER LINES RUN IN EXTERIOR WALLS SHALL BE LOCATED BETWEEN GYPBOARD & INSULATION TO PREVENT FREEZING. INSULATE ALL WATER LINES IN EXTERIOR WALLS WITH 2" THICK INSULATION. EXTERIOR WALL BUILDING INSULATION SHALL COMPLETELY

ENCOMPASS INSULATED PLUMBING PIPING WITHIN STUD CAVITY. 20. FOR DEMOLITION AND/OR RENOVATIONS, ALL HOLES THRU CONCRETE SHALL BE CORE-DRILLED. SAW-CUT ALL CONCRETE AND ASPHALT BEFORE BREAKING AND REMOVING. 21. INFORMATION OF EXISTING SERVICES WAS TAKEN FROM OWNER'S DRAWINGS. FIELD

LOCATE ALL EXISTING SERVICES PRIOR TO STARTING ANY WORK. 22. IT IS THE RESPONSIBILITY OF THE CONTRACTOR TO ENSURE THAT ALL WATER DISTRIBUTION PIPING IS ROUTED IN AREAS THAT ARE NOT SUBJECT TO FREEZING TEMPERATURES. IF PIPING IS SHOWN ROUTED IN SUCH AREAS AND NO PROVISION FOR FREEZE PROTECTION IS INDICATED, THE CONTRACTOR SHALL NOTIFY THE ARCHITECT / ENGINEER IMMEDIATELY.

23. PRIOR TO ANY SLAB DEMOLITION, CONTRACTOR SHALL LOCATE PIPING, ELECTRICAL CONDUIT, OR OTHER EQUIPMENT. ANY DAMAGE INCURRED BY THE GENERAL CONTRACTOR/SUB-CONTRACTOR IS TO BE REPAIRED/RESTORED AT NO EXPENSE TO THE OWNER OR ENGINEER.

24. HAND OPERATED FLUSH CONTROLS SHALL BE LOCATED ON THE OPEN SIDE OF THE WATER CLOSET EXCEPT IN AMBULATORY ACCESSIBLE COMPARTMENTS. 25. ANY CONTRACTOR WHO DESIRES TO INSTALL, ENLARGE, ALTER, REPAIR, MOVE OR REPLACE A PLUMBING SYSTEM, THE INSTALLATION OF WHICH IS REGULATED BY THIS CODE, SHALL FIRST MAKE APPLICATION AND OBTAIN THE REQUIRED PERMIT FOR THE WORK AS PER SECTION # 106.1

26. ALL PLUMBING INSTALLATIONS SHALL CONFORM TO THE 2015 IPC WITH LOCAL AMENDMENTS. ALL PLUMBING WORK TO BE SUBJECT TO FIELD INSPECTOR'S APPROVAL.

PLUMBING GENERAL NOTES N.T.S.

PRODUCTS

A. SANITARY SEWER PIPING, BURIED

1. PVC PIPE: ASTM D-2665, D-1785, SCHEDULE 40 PVC DWV. A. FITTINGS: PVC DWV

B. JOINTS: ASTM D2855, SOLVENT WELD WITH ASTM D2564 SOLVENT CEMENT. 2. CAST IRON PIPE: ASTM A74, SERVICE WEIGHT.

ALL PIPE AND FITTINGS SHALL BE MARKED WITH THE COLLECTIVE TRADEMARK OF THE CAST IRON SOIL PIPE INSTITUTE AND LISTED BY NSF INTERNATIONAL.

A. FITTINGS: CAST IRON. B. JOINTS: ASTM C-564, NEOPRENE GASKETING SYSTEM.

B. SANITARY SEWER PIPING, ABOVE GRADE

1. PVC PIPE: ASTM D-2665, D-1785, SCHEDULE 40 PVC DWV. (PROHIBITED IN RETURN AIR PLENUMS) A. FITTINGS: PVC

B. JOINTS: ASTM D2855, SOLVENT WELD WITH ASTM D2564 SOLVENT CEMENT. 2. CAST IRON PIPE: CISPI 301, ASTM A 888, HUBLESS, SERVICE WEIGHT.

ALL PIPE AND FITTINGS SHALL BE MARKED WITH THE COLLECTIVE TRADEMARK OF THE CAST IRON SOIL PIPE INSTITUTE AND LISTED BY NSF INTERNATIONAL. A. FITTINGS: CAST IRON.

B. JOINTS: NEOPRENE GASKETS AND S/S CLAMP AND SHIELD ASSEMBLIES. C. WATER PIPING ABOVE GRADE

1. COPPER TUBING: ASTM B88 , TYPE L, HARD DRAWN. A. FITTINGS: ASME B16.18, CAST BRONZE, OR ASME B16.22, WROUGHT COPPER AND BRONZE.

B. JOINTS: ASTM B32, SOLDER, GRADE 95TA.

D. GLASS FIBER PIPE INSULATION: 1. INSULATION: ASTM C547; RIGID MOLDED, NON COMBUSTIBLE. WITH ALL SERVICE JACKET. "K" VALUE = .024 @ 75^ F.

2. VAPOR BARRIER JACKET, ASTM C921, WHITE KRAFT PAPER REINFORCED WITH GLASS FIBER YARN AND BONDED TO ALUMINIZED FILM.

PIPE SIZE THICKNESS **INSULATION SCHEDULE:** DOMESTIC HOT WATER SUPPLY ALL 1/2" DOMESTIC COLD WATER SUPPLY ALL CONDENSATE DRAINS 1/2"

E. PIPE HANGERS AND SUPPORTS 1. PLUMBING PIPING - DWV & WATER PIPING.

A. CONFORM TO ASME B31.9. B. HANGERS FOR PIPE SIZES 1/2" TO 1-1/2": MALLEABLE IRON, ADJUSTABLE SWIVEL, CLEVIS.

2. PROVIDE SHEET METAL SHIELDS AT HANGER LOCATIONS. 3 SCHEDULES


PIPE SIZE MAX. SUPPORT BRACING) HANGER ROD DIAMETER (FEET) 1/2" TO 1-1/4" 1-1/2" TO 2"

PLUMBING LEGEND SYMBOL DESCRIPTION COLD WATER (CW) _____ HOT WATER (HW) ____ . . ____ HOT WATER RETURN (HWR) ____ - - - ____ CONNECT TO EXISTING

TYPE MARK DESCRIPTION SOIL WASTE VENT CW HW MXV REM		REMARKS						
L-1	LAVATORY, WALL HUNG		2"	2"	1/2"	1/2"		"ZURN" # 5344, BOWL, 4" CENTERS, Z8743-PC GRID STRAINER, Z8700-8B-PC TRAP, Z8802LRLK SUPPLIES W/LOOSE KEY STOPS. ZURN Z-1231 CARRIER, ZURN Z7440-XL LEVER CONTROL FAUCET.
S-1	SINK, COUNTERTOP DROP-IN, SINGLE BOWL		2"	2"	1/2"	1/2"		"ELKAY" #LR2522SC, 18 GA STAINLESS STEEL SINK + FAUCET KIT, ELKAY LK18B DRAIN FITTING STAINLESS STEEL BODY STRAINER AND TAILPIECE, LK500 P-TRAP, Z8802LRLK SUPPLIES WITH LOOSE KEY STOPS FAUCET – "ELKAY" LK810GN04T4SC CONCEALED DECK FAUCET (INCLUDED) WITH 5" GOOSENECK SPOUT, 4" WRISTBLADE HANDLE+SUPPLIES STOPS DRAIN.
W-1	WATER CLOSET, FLOOR MOUNTED, FLUSH VALVE	3"		2"	1"			"ZURN" # Z5655-BWL, "ZURN" NO. Z6000AV-WS1 (1.6 GPF) FLUSH VALVE, "ZURN" # Z5955SS-EL, ELONGATED WHITE TOILET SEAT AT 15" STANDARD HEIGHT.

KEYNOTE SYMBOL MECHANICAL EQUIPMENT TAG

PLUMBING FIXTURE SCHEDULE

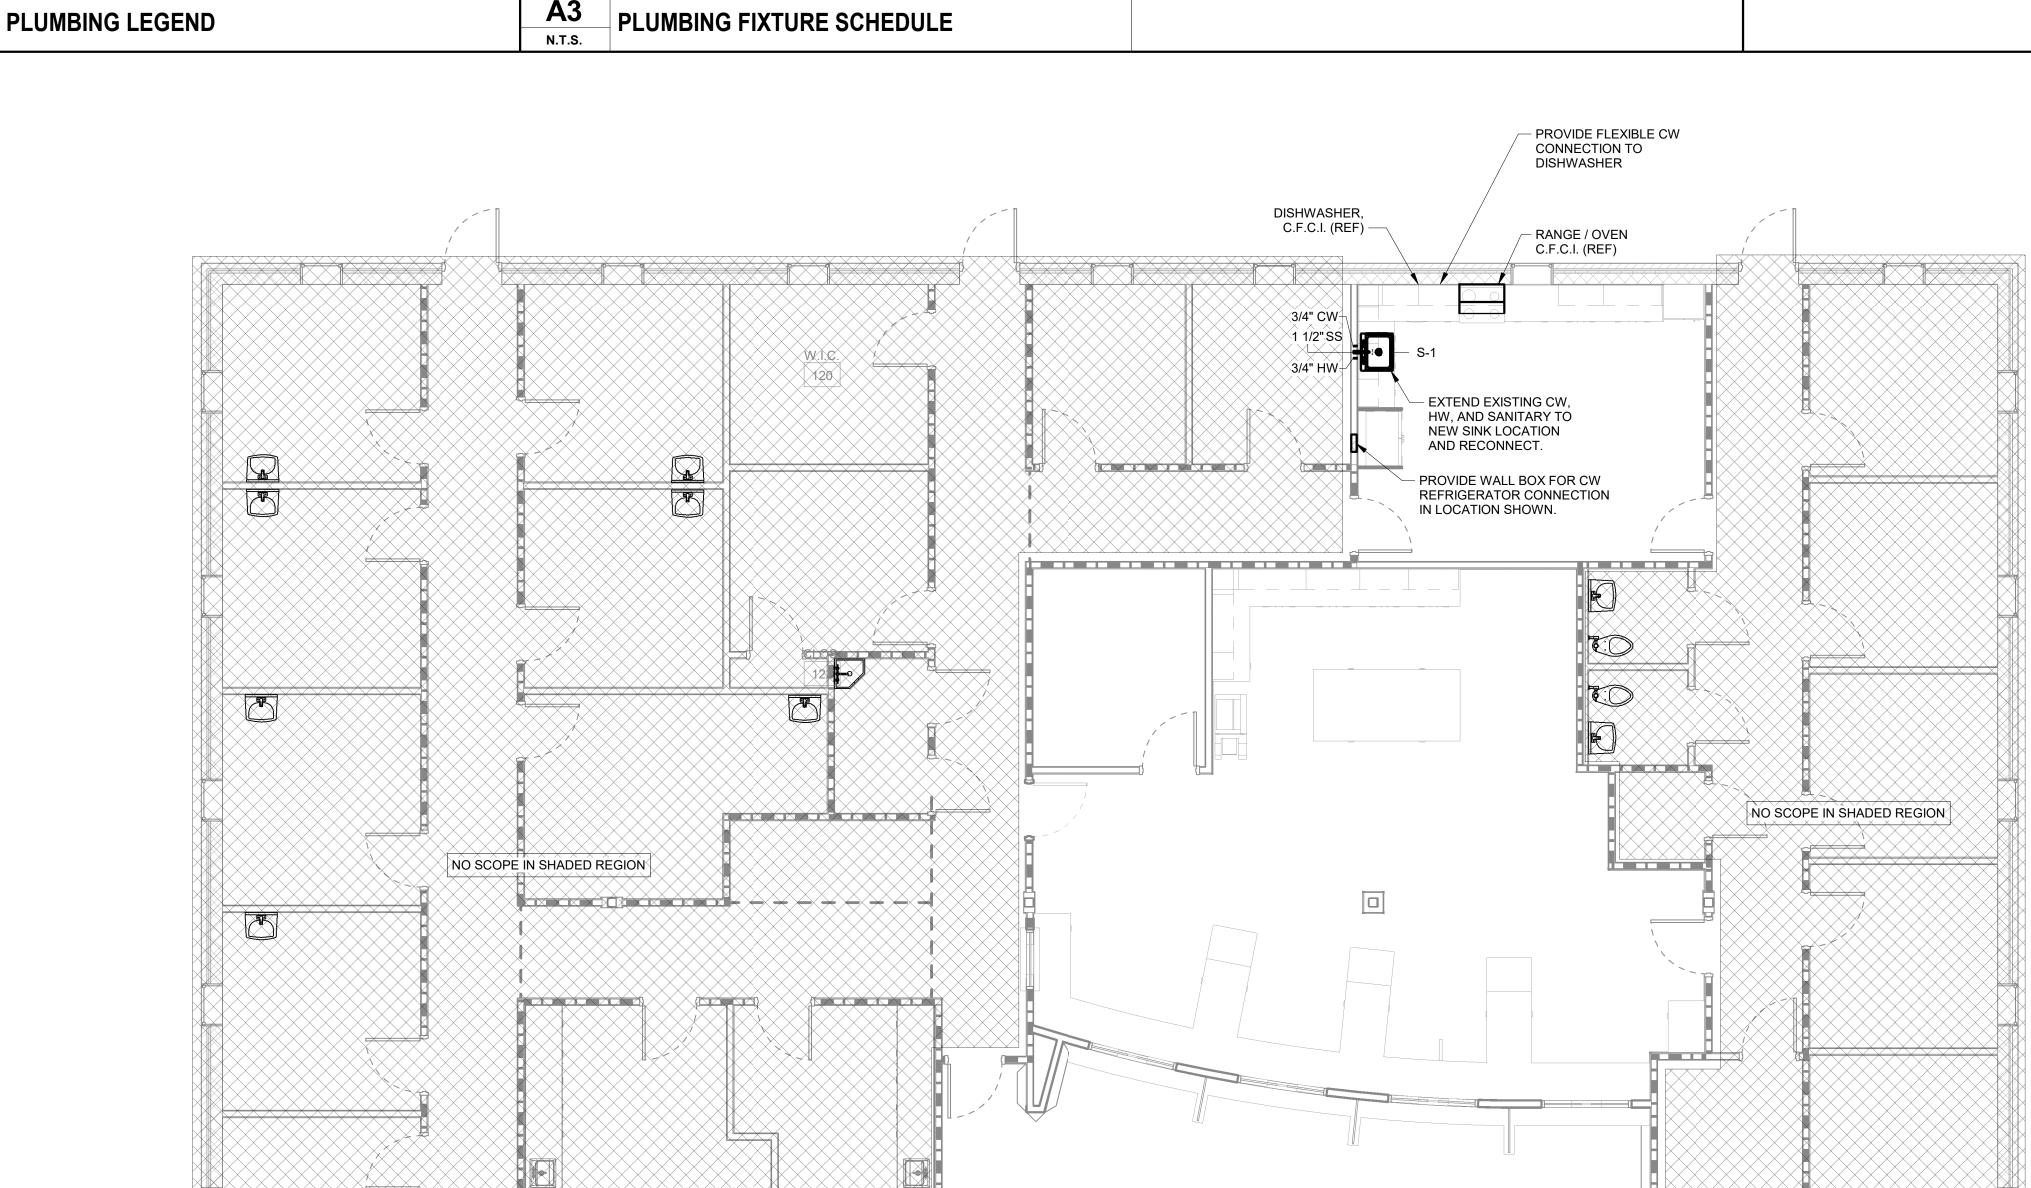

REWORK EXISTING

.1" CW≘

3"SS ##

[×]3/4" CW_≍

1 1/4"SS

SANITARY, CW, HW,

TO NEW FIXTURE.

REWORK EXISTING IL

TO NEW FIXTURE.

AND VENT TO CONNECT

REWORK EXISTING SANITARY, CW, HW,

TO NEW FIXTURE.

SANITARY, CW, HW,

AND VENT TO CONNECT

AND VENT TO CONNECT

THESE DRAWINGS ARE DIAGRAMMATIC COORDINATION OF ALL TRADES AND COMPLIANCE WITH DIMENSIONS ON ARCHITECTURAL AND STRUCTURAL DRAWINGS ARE REQUIRED

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FAYETTE COUNTY HEALTH **DEPARTMENT**

FAYETTE COUNTY

CONSTRUCTION **DOCUMENTS**

REVISIONS

DATE PROJECT JUNE 20, 2024

CHECKED

DRAWN


PLUMBING FLOOR PLAI

PLUMBING DETAILS & SPECIFICATIONS N.T.S.

3/16" = 1'-0"

N.T.S.

OVERALL PLUMBING FLOOR PLAN

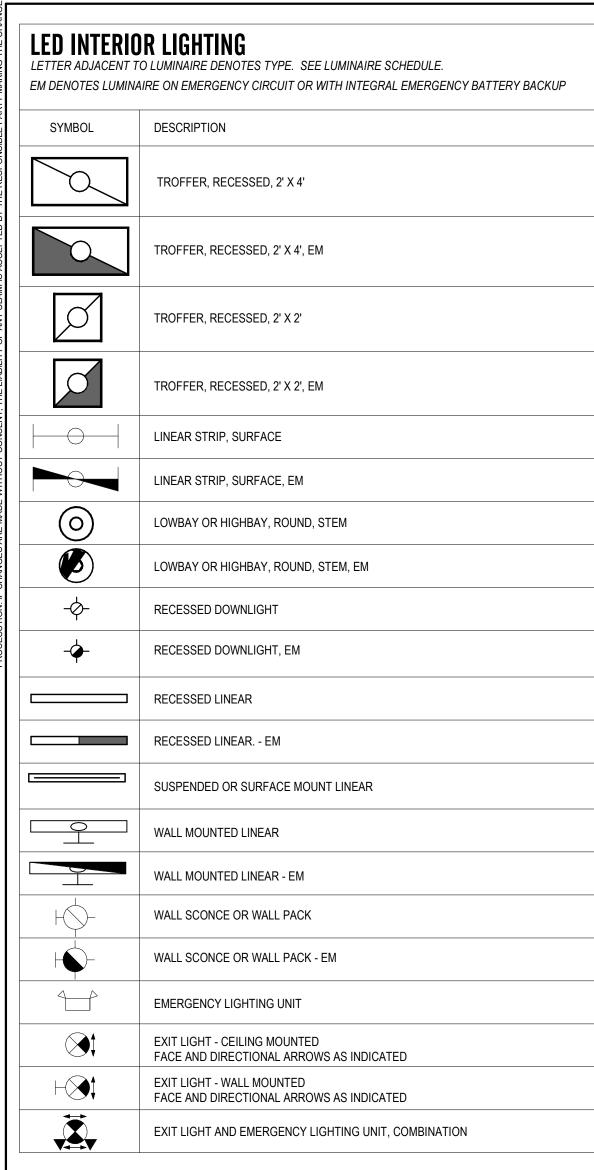

LETTER ADJACEN	RIOR LIGHTING IT TO LUMINAIRE DENOTES TYPE. SEE LUMINAIRE SCHEDULE. IINAIRE ON EMERGENCY CIRCUIT OR WITH INTEGRAL EMERGENCY BATTERY BACKUP
SYMBOL	DESCRIPTION
	AREA LUMINAIRE ON POLE, SINGLE
$\bigcirc \longrightarrow \bigcirc$	AREA LUMINAIRE ON POLE, TWIN
+	WALL MOUNTED LUMINAIRE
	WALL MOUNTED LUMINAIRE, EM
-	BOLLARD

SYMBOL	DESCRIPTION
	PANELBOARD, 208Y/120V 3PH 4W
	PANELBOARD, 480Y/277V 3PH 4W
	AUTOMATIC TRANSFER SWITCH
Т	TRANSFORMER
	SAFETY SWITCH, NON-FUSED, 60/3 OR SIZE NOTED
	SAFETY SWITCH, FUSED, 60/3 OR SIZE NOTED
⊙ ⊙	DIRECT CONNECTION TO EQUIPMENT
	EMERGENCY SHUTDOWN SWITCH FOR EMERGENCY SERVICES AND UTILITY COMPANY KEY, CONNECT SHUNT TRIP BREAKER

CONDUCTORS, CABLES, BOXES, AND GROUNDING						
SYMBOL	DESCRIPTION					
	CONDUCTORS IN CONDUIT CONCEALED IN OR ABOVE CEILING OR IN WALL					
<u></u> +	CONDUCTORS IN CONDUIT CONCEALED BELOW FLOOR, IN SLAB OR BELOW GRADE					
7	EQUIPMENT GROUNDING CONDUCTOR					
	CONDUCTORS IN CONDUIT EXPOSED ON CEILING OR WALL					
J	JUNCTION BOX, ABOVE CEILING, UON					
GB	GROUND BAR					
IBT	GROUND BAR - INTERSYSTEM BONDING TERMINATION					

WIRING DEVICES

SYMBOL DESCRIPTION	
TR WR SUBSCRIPTS: TR - TAMPER RESISTANT, U - UNIVERSAL SERIAL BUS (USB) M U DEVICE POWER (2-PORT), WR - WEATHER-RESISTANT	
=	RECEPTACLE, DUPLEX, NEMA 5-20R
⊖ =	RECEPTACLE, DUPLEX, GFCI, NEMA 5-20R
\(\phi\)	RECEPTACLE, DUPLEX, NEMA 5-20R, COUNTERTOP HEIGHT
\$	RECEPTACLE, DUPLEX, GFCI, NEMA 5-20R, COUNTERTOP HEIGHT
#	RECEPTACLE, TWO DUPLEX IN ONE OUTLET (QUADPLEX)
RECEPTACLE, QUADPLEX, GFCI, NEMA 5-20R, COUNTERTOP HEIGHT	
RECEPTACLE, SINGLE, NEMA 5-20R	
RECEPTACLE, NEMA 14-30R UNLESS OTHERWISE NOTED	
Ø -	RECEPTACLE, SPECIAL, AS NOTED
⊜	RECEPTACLE, CEILING, DUPLEX, NEMA 5-20R
FLOOR BOX, SINGLE FITTING, RECEPTACLE, DUPLEX NEMA 5-20R RECTANGULAR METAL FLIP COVER	
FLOOR BOX, CAST IN PLACE, SHARED WITH COMMUNICATIONS WIRING DEVICE SERVICE FITTINGS: (2) DUPLEX, NEMA 5-20R USB TYPE	
FLOOR BOX, POKE THROUGH, SHARED WITH COMMUNICATIONS WIRING DEVICE SERVICE FITTINGS: (2) DUPLEX, NEMA 5-20R USB TYPE	
\$ TOGGLE SWITCH, MOTOR RATED, WITH POLES FOR LOAD SERVED.	

DEVICES ARE I	LINE VOLTAGE, WALL MOUNTED, UON.
SYMBOL	DESCRIPTION
\$	SWITCH TOGGLE, SPST, 20A, 120V
\$ ₃	SWITCH, THREE WAY
\$ _{os}	SWITCH, VACANCY SENSING
\$ _D	SWITCH, DIMMING, 0-10V
\$ _{OSD}	SWITCH, VACANCY SENSING, 0-10V DIMMING
\$ _{os2}	SWITCH, VACANCY SENSING, 2 POLE
\$ _K	SWITCH, KEY OPERATED, MOMENTARY TURN FOR ON, SPRING LOAD OFF, UON

NETWORK	NETWORK LIGHTING CONTROLS			
	DEVICES ARE LOW VOLTAGE NETWORK TYPE, UON. LV - LOW VOLTAGE, D - DIMMING, # - BUTTONS,			
\$ _{LV}	SWITCH, ON/OFF			
\$ LVD	SWITCH, LOW VOLTAGE NETWORK, ON/OFF, DIMMING			
\$ _{2D}	SWITCH, LOW VOLTAGE NETWORK, ON/OFF, DIMMING, 2 ZONE			
↔	OCCUPANCY SENSOR, LOW VOLTAGE NETWORK, CEILING			
*	OCCUPANCY SENSOR, LOW VOLTAGE NETWORK, WALL			
(B)	DAYLIGHT SENSOR, CEILING			
<u>a</u>	POWER PACK, NON DIMMABLE			
<u>a</u>	POWER PACK, NON DIMMABLE, UL 924 EMERGENCY OVERRIDE			
	POWER PACK, DIMMING, 0-10V			
	POWER PACK, DIMMING, 0-10V, UL924 EMERGENCY OVERRIDE			
[LCP]	LIGHTING CONTROL PANEL, SINGLE PANEL OR COLLECTION OF NETWORK DEVICES AS NOTED			
TC	LIGHTING CONTROLLER WITH TIME CLOCK AND PHOTOCELL INPUT			

SYMBOL	DESCRIPTION
\triangleright	DATA OUTLET. 1-IN C WITH PULLSTRING TO ACCESSIBLE CEILING SPACE
⊳	DATA OUTLET, COUNTER HEIGHT. 1-IN C WITH PULLSTRING TO ACCESSIBLE CEILING SPACE
\Diamond	TELEVISION (TV) OUTLET. SINGLE GANG BOX AT 18-IN AFF. 1.25-IN C WITH PULLSTRING TO ACCESSIBLE CEILING SPACE.
•	DATA OUTLET RECESSED IN CEILING.
<u></u>	SPEAKER, FLUSH CEILING MOUNTED
CR	CARD READER. SINGLE GANG BOX 48-IN AFF. 1/2-IN C WITH PULLSTRING TO ACCESSIBLE CEILING SPACE.
>	CAMERA, INTERIOR, CELING MOUNTED UNLESS OTHERWISE NOTED.
	CAMERA, EXTERIOR, WALL MOUNTED UNLESS OTHERWISE NOTED.
	FLOOR BOX, SINGLE FITTING, DATA OUTLET, 1-IN CONDUIT AND STRING TO ABOVE CEILING.
8	FLOOR BOX, CAST IN PLACE, SHARED WITH POWER, WIRING DEVICE SERVICE FITTINGS: (2) 1-GANG OUTLETS, 1.25-IN CONDUIT AND STRING TO ABOVE CEILING
FB	FLOOR BOX, POKE THROUGH, SHARED WITH POWER, WIRING DEVICE SERVICE FITTINGS: (2) 1-GANG OUTLETS, 1.25-IN EMT AND STRING TO ABOVE CEILING

ADDRESSABLE FIRE ALARM SYSTEM			
SYMBOL	DESCRIPTION		
FACP	FIRE ALARM CONTROL PANEL		
FAA	ANNUNCIATOR PANEL		
<u>\$</u>	SMOKE DETECTOR, CEILING MOUNTED		
© _S	SMOKE DETECTOR, DUCT MOUNTED, (S) SUPPLY (R) RETURN		
	NOTIFICATION APPLIANCE, VISUAL, CANDELA AS INDICATED ON PLANS		
	NOTIFICATION APPLIANCE, COMBINATION AUDIBLE & VISUAL, CANDELA AS INDICATED ON PLANS		
Ø <u>I</u> LL	NOTIFICATION APPLIANCE, COMBINATION SPEAKER & VISUAL, CANDELA AS INDICATED ON PLANS		
Ш	MANUAL PULL STATION		
FS	FLOW SWITCH		
TS	TAMPER SWITCH		
PS	PRESSURE SWITCH		

ELECTRICAL GENERAL NOTES

- 1. PROVIDE LABOR AND MATERIALS NECESSARY FOR A COMPLETE AND FULLY FUNCTIONAL ELECTRICAL SYSTEM. INCLUDE LABOR, INSTALLATION METHODS, EQUIPMENT, AND MATERIALS FOR WORK REQUIRED FOR THE INSTALLATION AS SHOWN ON DRAWINGS AND AS DESCRIBED IN THE SPECIFICATIONS. ADHERE TO MORE STRINGENT REQUIREMENTS THAN THOSE DESCRIBED HEREIN OR AS SET FORTH UNDER CODES, LAWS, AND ORDINANCES OF FEDERAL, STATE, AND LOCAL AUTHORITIES HAVING JURISDICTION. ERECT, INSTALL, TOOL, CONNECT, CLEAN, ADJUST, TEST, CONDITION, AND PLACE MATERIALS AND EQUIPMENT IN ACCORDANCE WITH THE MANUFACTURER'S DIRECTIONS AND RECOMMENDATIONS.
- COMPLY WITH THE RULES AND REGULATIONS OF THE AUTHORITIES HAVING JURISDICTION INCLUDING: AMERICAN WITH DISABILITIES ACT
- GOVERMENTAL FEES: 1. SECURE AND PAY FOR PERMITS, GOVERNMENTAL FEES, TAXES AND LICENSES NECESSARY FOR
- THE PROPER EXECUTION AND COMPLETION OF ELECTRICAL WORK. 2. PREPARE AND SUBMIT TO GOVERNMENTAL AGENCIES, UTILITY COMPANIES, AND LOCAL CODE OFFICIALS, SHOP DRAWINGS AND/OR INSTALLATION DETAILS WHICH ARE REQUIRED BY THESE AGENCIES FOR THEIR APPROVAL.
- 5. NO PART OF THE DESIGN IS TO BE CHANGED WITHOUT THE PRIOR APPROVAL OF THE ENGINEER.
- 1. ENSURE MATERIALS AND EQUIPMENT ARE LISTED AND/OR LABELED BY U.L., ETL, CSA, OR ANOTHER NATIONALLY RECOGNIZED TESTING LABORATORY (NRTL). PROVIDE COMMERCIAL GRADE MATERIAL, EQUIPMENT, WIRING DEVICES, UNLESS SPECIFICALLY INDICATED AS EXISTING TO BE REUSED ON
- 2. NOTIFY THE ARCHITECT, ENGINEER, AND PROJECT MANAGER IN WRITING OF MATERIALS OR APPARATUS BELIEVED TO BE INADEQUATE, UNSUITABLE, IN VIOLATION OF LAWS, ORDINANCES, RULES, OR REGULATIONS OF THE AUTHORITIES HAVING JURISDICTION.
- 3. EXAMINE THE CONTRACT DOCUMENTS AND MAKE A SCHEDULED ARRANGEMENT WITH THE PROJECT MANAGER TO VISIT THE SITE TO BECOME FAMILIAR WITH THE BUILDING AND SITE CONDITIONS RELATING TO THE WORK. FAILURE TO DO SO WILL NOT RELIEVE OBLIGATIONS OF THE CONTRACT.
- 4. <u>TEMPORARY POWER AND LIGHTING</u>: PROVIDE FOR THE PERFORMANCE OF OTHER TRADES, FOR THE ENTIRE PERIOD OF CONSTRUCTION. REMOVE TEMPORARY WIRING AT THE COMPLETION OF CONSTRUCTION. INCLUDE COST FOR ESTABLISHING AND REMOVING TEMPORARY POWER IN BID.
- SUBMITTALS: ARRANGE IN LOGICAL GROUPS TO REFLECT SPECIFICATION SECTIONS. INCLUDE MANUFACTURER'S NAMES, CATALOG NUMBERS, CUTS, DIAGRAMS, AND OTHER DESCRIPTIVE DATA TO IDENTIFY AND DESCRIBE THE EQUIPMENT. DELIVER COMPLETE SUBMITTAL PACKAGE AT ONE TIME. PARTIAL SUBMITTALS WILL NOT BE REVIEWED. INCOMPLETE OR INSUFFICIENT SUBMITTALS WILL BE RETURNED FOR CORRECTION.
- AS-BUILTS: PROVIDE AS-BUILT DOCUMENTATION AND HARD COPY REPRODUCIBLE DRAWINGS AT THE COMPLETION OF THE PROJECT AND SUBMIT TO THE ARCHITECT AND THE ENGINEER. INDICATE EXACT CIRCUIT NUMBERS, LOCATIONS OF DISTRIBUTION EQUIPMENT, DEVICES, CEILING FIXTURES, AND RACEWAYS FOR LIGHTING, TELECOMMUNICATIONS AND POWER DISTRIBUTION SYSTEMS AS INSTALLED.
- 7. COORDINATION WITH OTHER SYSTEMS:
- 1. VERIFY CLEARANCES FOR ELECTRICAL WORK BEFORE PROCEEDING WITH CONSTRUCTION. COORDINATE USAGE OF AVAILABLE SPACE WITH OTHER TRADES. IN THE EVENT OF CONFLICTS, NOTIFY THE ARCHITECT AND ENGINEER BEFORE PROCEEDING WITH THE WORK.
- 2. REFER TO MECHANICAL AND PLUMBING ENGINEERING DRAWINGS FOR LOCATIONS OF MECHANICAL AND PLUMBING EQUIPMENT

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FAYETTE COUNTY HEALTH **DEPARTMENT**

90 YUM YUM ROAD **SOMERVILLE, TN 38068**

> CONSTRUCTION **DOCUMENTS**

REVISIONS

PROJECT NO.	DATE
23406	JUNE 20, 20

ELECTRICAL LEGEND AND

SYMBOL		DESCRIPTION
FACP		FIRE ALARM CONTROL PANEL
	FAA	ANNUNCIATOR PANEL
	\$	SMOKE DETECTOR, CEILING MOUNTED
	© <u></u>	SMOKE DETECTOR, DUCT MOUNTED, (S) SUPPLY (R) RETURN
		NOTIFICATION APPLIANCE, VISUAL, CANDELA AS INDICATED ON PLANS
	Œ	NOTIFICATION APPLIANCE, COMBINATION AUDIBLE & VISUAL, CANDELA AS INDICATED ON PLANS
	Ø <u>I</u> LL	NOTIFICATION APPLIANCE, COMBINATION SPEAKER & VISUAL, CANDELA AS INDICATED ON PLANS
	ш	MANUAL PULL STATION
	FS	FLOW SWITCH
	TS	TAMPER SWITCH
	PS	PRESSURE SWITCH

ABBREVIATIONS N.T.S.

ABBREVIATIONS

AL ALUMINUM

APPX APPROXIMATELY

BOD BASIS OF DESIGN

CALORIE

CANDELA

COPPER

EXISTING

GROUND

GAUGE

GALV GALVANIZED

FAHRENHEIT FOOTCANDLE

CENTERLINE

DIMENSION

CAL

DIM

EBM

ECB

FMC

GES

LCP

LM

MNF

MBJ

FT

AMPERE TRIP

BRANCH CIRCUIT

BCB BRANCH CIRCUIT BREAKER BELOW FINISHED CEILING

AMPERE FRAME AFB ARC FLASH BOUNDARY AFC AVAILABLE FAULT CURRENT

> ABOVE FINISHED FLOOR ABOVE FINISHED GRADE AMPERE-HOURS

AUTHORITY HAVING JURISDICTION AMPERES INTERRUPTING CAPACITY

ASCA AVAILABLE SHORT CIRCUIT AMPERES

AUTOMATIC TRANSFER SWITCH

CONDUIT OR COUNTERTOP HEIGHT

EQUIPMENT BONDING JUMPER

ELECTRIC DRINKING FOUNTAIN

ECM ELECTRICALLY COMMUTATED MOTOR

EGC EQUIPMENT GROUNDING CONDUCTOR

FEEDER CIRCUIT BREAKER

FLEXIBLE METAL CONDUIT

GROUND BUS OR BUSBAR

GFPE GROUND FAULT PROTECTION

INSULATED CEILING RATED

LIGHTING CONTROL PANEL

LFMC LIQUIDTIGHT FLEXIBLE METAL CONDUIT

LIGHTING POWER ALLOWANCE

LIGHTING POWER DENSITY

MINIMUM CIRCUIT AMPACITY

MOP MAXIMUM OVERCURRENT PROTECTION

MAIN BONDING JUMPER

MCCB MOLDED CASE CIRCUIT BREAKER

OF EQUIPMENT

INCH OR INCHES

KILOAMPERES

MANUFACTURER

MCB MAIN CIRCUIT BREAKER

MGB MASTER GROUND BUS BAR

NORMALLY CLOSED NORMALLY OPEN NOT TO SCALE

PHOTOCONTROL SWITCH

SCCR SHORT CIRCUIT AMPERE RATING SMR SURFACE METAL RACEWAY SPD SURGE PROTECTION DEVICE

UNDERGROUND FEEDER

WEATHER - RESISTANT

UON UNLESS OTHERWISE NOTED

KELVIN

LUMEN

MLO MAIN LUG ONLY

MTG MOUNTING N/A NOT APPLICABLE

N.T.S. NOT TO SCALE ON CENTER ON CENTER

PNL PANELBOARD QTY QUANTITY

SQ SQUARE

TYP TYPICAL

SWB SWITCHBOARD SWG SWITCHGEAR TR TAMPER RESISTANT

VOLTS

VOLT-AMPS

EXISTING FEET

INCH

RACEWAY RMC RIGID METAL CONDUIT

SWITCHED

STAINLESS STEEL

GROUNDING ELECTRODE CONDUCTOR

GROUND FAULT CIRCUIT INTERRUPTING

INTERSYSTEM BONDING TERMINATION

GROUNDING ELECTRODE SYSTEM

EFD ENCLOSED FUSED DISCONNECT EGB EXTERNAL GROUND BUS BAR

EMT ELECTRICAL METALLIC TUBING

EXTENDED BATTERY MODULE ENCLOSED CIRCUIT BREAKER

AMERICAN WIRE GAUGE

BELOW FINISHED GRADE

GENERAL NOTES N.T.S.

ELECTRICAL LEGEND

N.T.S.

N.T.S.

N.T.S.

N.T.S.

2 H ENGINEERS ARCHITECTS PLANNERS

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FAYETTE COUNTY
HEALTH
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90 YUM YUM ROAD SOMERVILLE, TN 3806

CONSTRUCTION DOCUMENTS

REVISIONS

PROJECT NO.
23406

DRAWN

CHECKED

Checker

ELECTRICAL SPECIFICATIONS

E0.1

ENGINEERS ARCHITECTS PLANNERS

KEYED NOTES (#)

1 REMOVE EXISTING LIGHTS AND CONTROLS IN THIS AREA.
MAINTAIN CIRCUIT FOR CONNECTION TO NEW FIXTURES.

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5 12" = 1'-0" KEYED NOTES



FAYETTE COUNTY, TN

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CONSTRUCTION DOCUMENTS

REVISIONS

PROJECT NO. DATE
23406 JUNE 20, 2024

DRAWN CHECKED

LIGHTING - DEMOLITION FLOOR PLAN

F1 1

INTERIOR LUMINAIRE SCHEDULE									
TYPE	DESCRIPTION	MANUFACTURER	MODEL	COLOR	LUMENS	DIMMING	WATTS	MOUNTING	REMARKS
Α	2X2 TROFFER	MANUF	FLUL-22-PS-3000L-35K-LD1-120	3500K	3000	0-10V 10%	23 VA	RECESSED	REMARK
В	4" ROUND DOWNLIGHT		4RN + Z4RDL20935WOBKZ10U	3500K	2000	0-10V 10%	21 VA	RECESSED	
С	2X4 TROFFER		FLUL-24-PS-3000L-35K-LD1-120	3500K	3000	0-10V 10%	25 VA	RECESSED	
D4	LINEAR 4FT		FSM4L-FL-625LF-35K-1C-UNV-LD1-G1-4'-0"	3500K	625/FT	0-10V 10%	22 VA	RECESSED	
D22	LINEAR 22FT		FSM4L-FL-625LF-35K-1C-UNV-LD1-G1-22'-0"	3500K	625/FT	0-10V 10%	88 VA	RECESSED	
D32	LINEAR 32FT		FSM4L-FL-625LF-35K-1C-UNV-LD1-G1-32'-0"	3500K	625/FT	0-10V 10%	176 VA	RECESSED	
D36	LINEAR 36FT		FSM4L-FL-625LF-35K-1C-UNV-LD1-G1-36'-0"	3500K	625/FT	0-10V 10%	220 VA	RECESSED	
F	STRIP LIGHT		CLX-48-4000LM-SEF-FDL-120-GZ10-35K-80CRI	3500K	4000	0-10V 10%	30 VA	SURFACE	
N	EMERGENCY LIGHT		EU2L	N/A		N/A	2 VA	WALL MOUNT	
Х	EXIT SIGN		LQM-S-3-R-120/277-EL N	N/A		N/A	1 VA	CEILING MOUNT	

SUBMITTALS AND SUBSTITUTIONS:

- MANUFACTURER'S TRADE NAMES OR CATALOG NUMBERS USED IN THIS SCHEDULE ARE A BASIS OF DESIGN TO DENOTE TYPE, SIZE, QUALITY, AND DESIGN OF EQUIPMENT REQUIRED. SEE SPECIFICATIONS FOR LIST OF PRE-APPROVED ALTERNATE MANUFACTURERS AND AGENCIES.
- SUBMIT DATA SHEETS AND SHOP DRAWINGS FROM MANUFACTURER TO VERIFY SELECTIONS AND CONNECTIONS. SUBMITTAL DATA SHEETS SHALL BE ON LETTERHEAD OF AGENCY REPRESENTING MANUFACTURERS IN THE TERRITORY WHERE THE PROJECT IS LOCATED.
- WHERE A SUBSITUTE LIGHTING PACKAGE IS SUBMITTED FOR ENGINEER REVIEW, PROVIDE ALL FIXTURE CUTSHEETS WITH OPTIONS CLEARLY INDICATED. PROVIDE AN ELECTRONIC COPY OF PHOTOMETRIC CALCULATIONS FOR EACH SPACE WITH VISUAL LIGHTING SOFTWARE.
- 4. FURNISH SPECIFIED MATERIALS WHERE SUBSTITUTIONS ARE NOT APPROVED.

N.T.S.

LUMINAIRE SCHEDULE

LIGHTING CONTROLS NARRATIVE:

PROVIDE WIRED LOW VOLTAGE INFRARED OCCUPANCY SENSORS, POWER PACKS AND SWITCHES BY WATTSTOPPER OR EQUAL.


VACANCY SENSOR OPERATION - MANUAL ON/AUTO OFF AFTER TIME DELAY


VACANCY SENSOR OPERATION - MANUAL ON/AUTO OFF AFTER TIME DELAY

MED RECORDS/RECEPTION 146 VACANCY SENSOR OPERATION - MANUAL ON/AUTO OFF AFTER TIME DELAY

WAITING 101/VESTIBULE 100
OCCUPANCY SENSOR OPERATION - AUTO ON/AUTO OFF AFTER TIME DELAY

VACANCY SENSOR OPERATION - MANUAL ON/AUTO OFF AFTER TIME DELAY

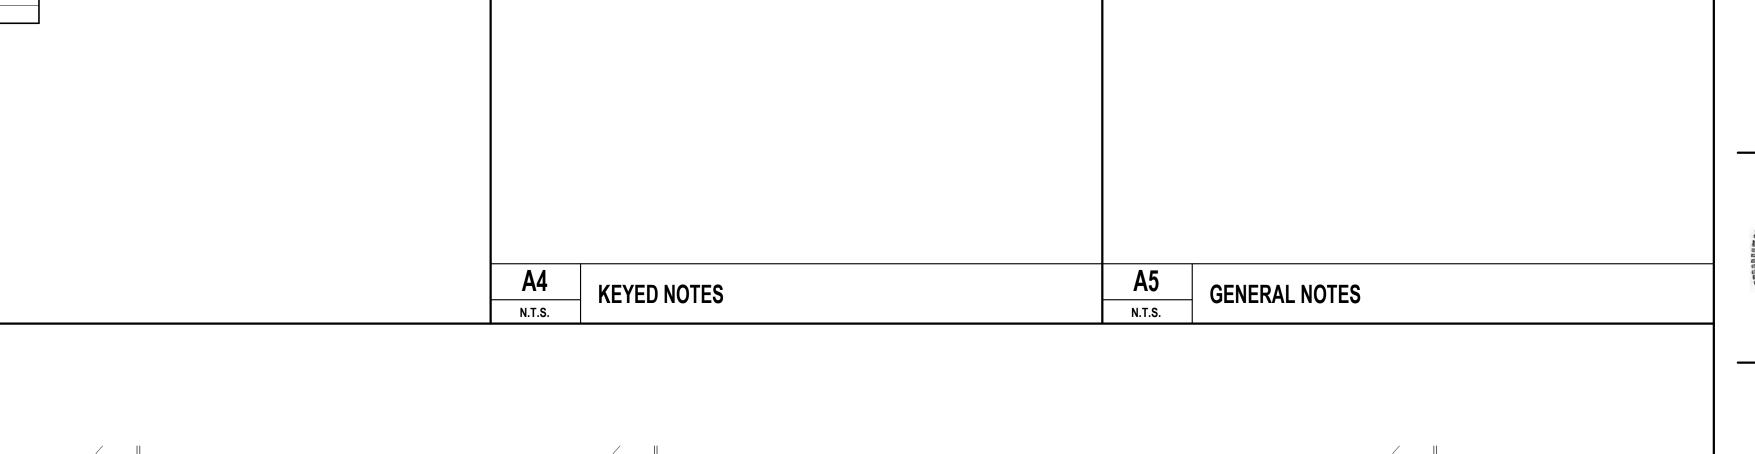

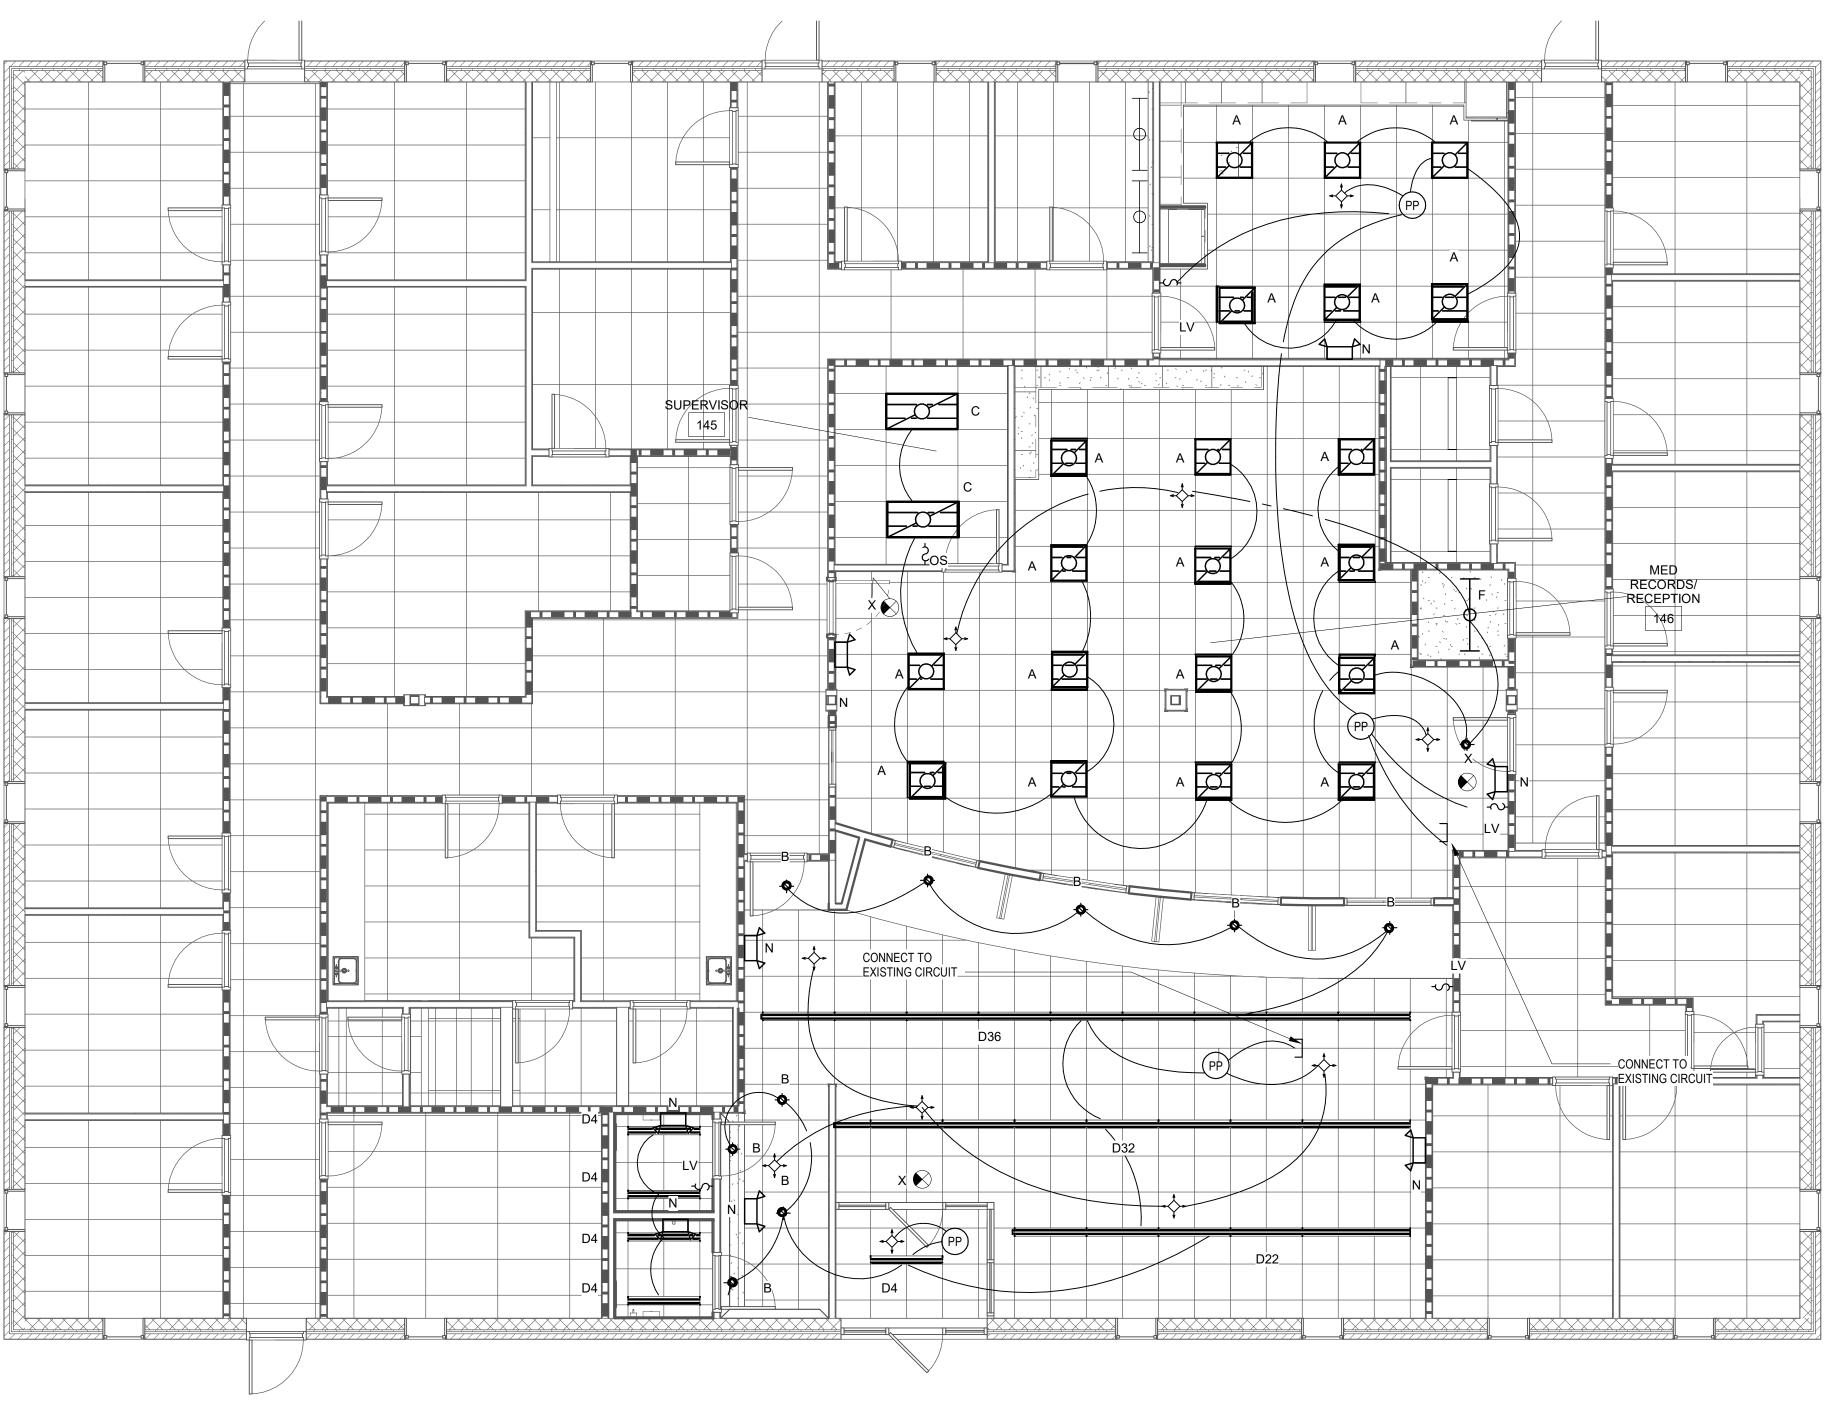

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> CONSTRUCTION **DOCUMENTS**

> > REVISIONS

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LIGHTING - FIRST FLOOR PLAN


LIGHTING PLAN

- 1. SEE SHEET E0.0.
- 2. PROVIDE ELECTRICAL DISTRIBUTION SYSTEM.

KEYED NOTES (#)

- PROVIDE 20A CIRCUIT TO EXISTING PANEL OR UTILIZE EXISTING CIRCUIT FREED UP FROM DEMOLITION
- 2. PROVIDE A NEW 50A AND CIRCUIT FOR RANGE. CONNECT TO EXISTING OVEN/RANGE BREAKER.
- 3 PROVIDE 20A CIRCUIT TO EXISTING PANEL. PROVIDE 20/1 GFCI BREAKER IN AVAILABLE SPACE IN PANELBOARD.
- PROVIDE RECESSED RECEPTACLE AT PRINTER SHELF. ROUTE CONDUIT IN CASEWORK CAVITY AT FLOOR LEVEL.

A5	GENERAL AND KEYED NOTES	
N.T.S.		

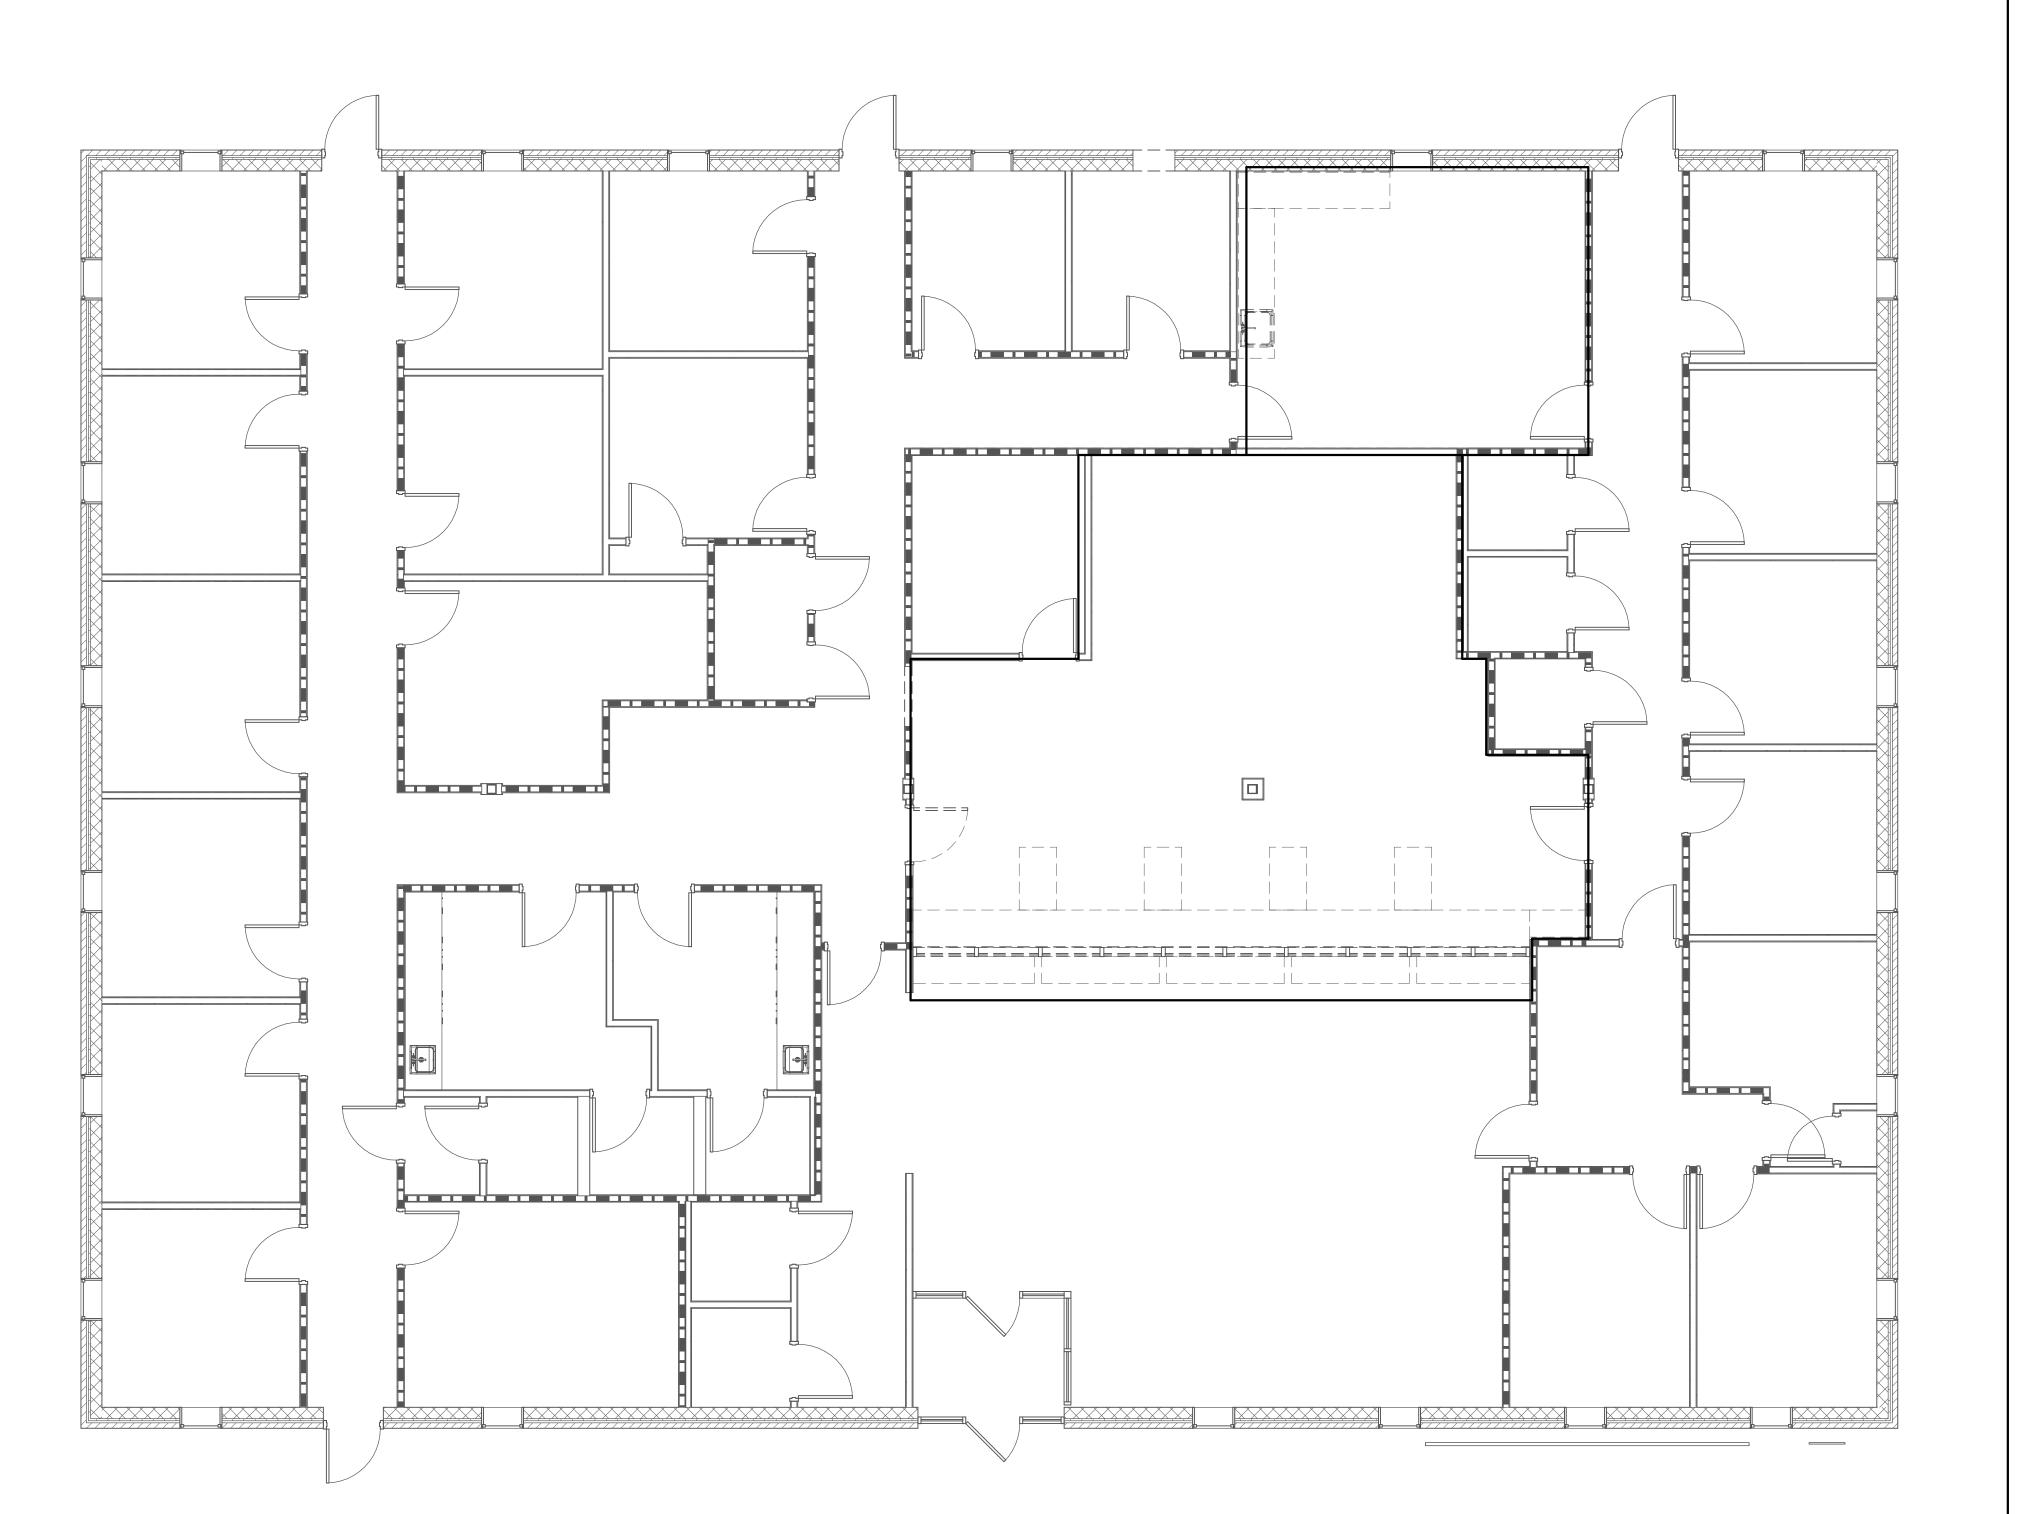

ENGINEERS ARCHITECTS PLANNERS

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HEALTH
DEPARTMENT

90 YUM YUM ROAD SOMERVILLE, TN 38068

CONSTRUCTION DOCUMENTS

PROJECT NO. DATE
23406 JUNE 20, 2024

DRAWN CHECKED

POWER - DEMOLITION FLOOR PLAN

=2₋1

- 1. SEE SHEET E0.0.
- 2. PROVIDE ELECTRICAL DISTRIBUTION SYSTEM.

KEYED NOTES (#)

- PROVIDE 20A CIRCUIT TO EXISTING PANEL OR UTILIZE EXISTING CIRCUIT FREED UP FROM DEMOLITION
- 2. PROVIDE A NEW 50A AND CIRCUIT FOR RANGE. CONNECT TO EXISTING OVEN/RANGE BREAKER.
- 3 PROVIDE 20A CIRCUIT TO EXISTING PANEL. PROVIDE 20/1 GFCI BREAKER IN AVAILABLE SPACE IN PANELBOARD.
- 4. PROVIDE RECESSED RECEPTACLE AT PRINTER SHELF. ROUTE CONDUIT IN CASEWORK CAVITY AT FLOOR LEVEL.

A5	GENERAL AND KEYED NOTES
N.T.S.	



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FAYETTE COUNTY HEALTH DEPARTMENT

90 YUM YUM ROAD SOMERVILLE, TN 38068

CONSTRUCTION DOCUMENTS

REVISIONS


PROJECT NO. DATE

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CHECKED

POWER - FIRST FLOOR PLAN

E2.2

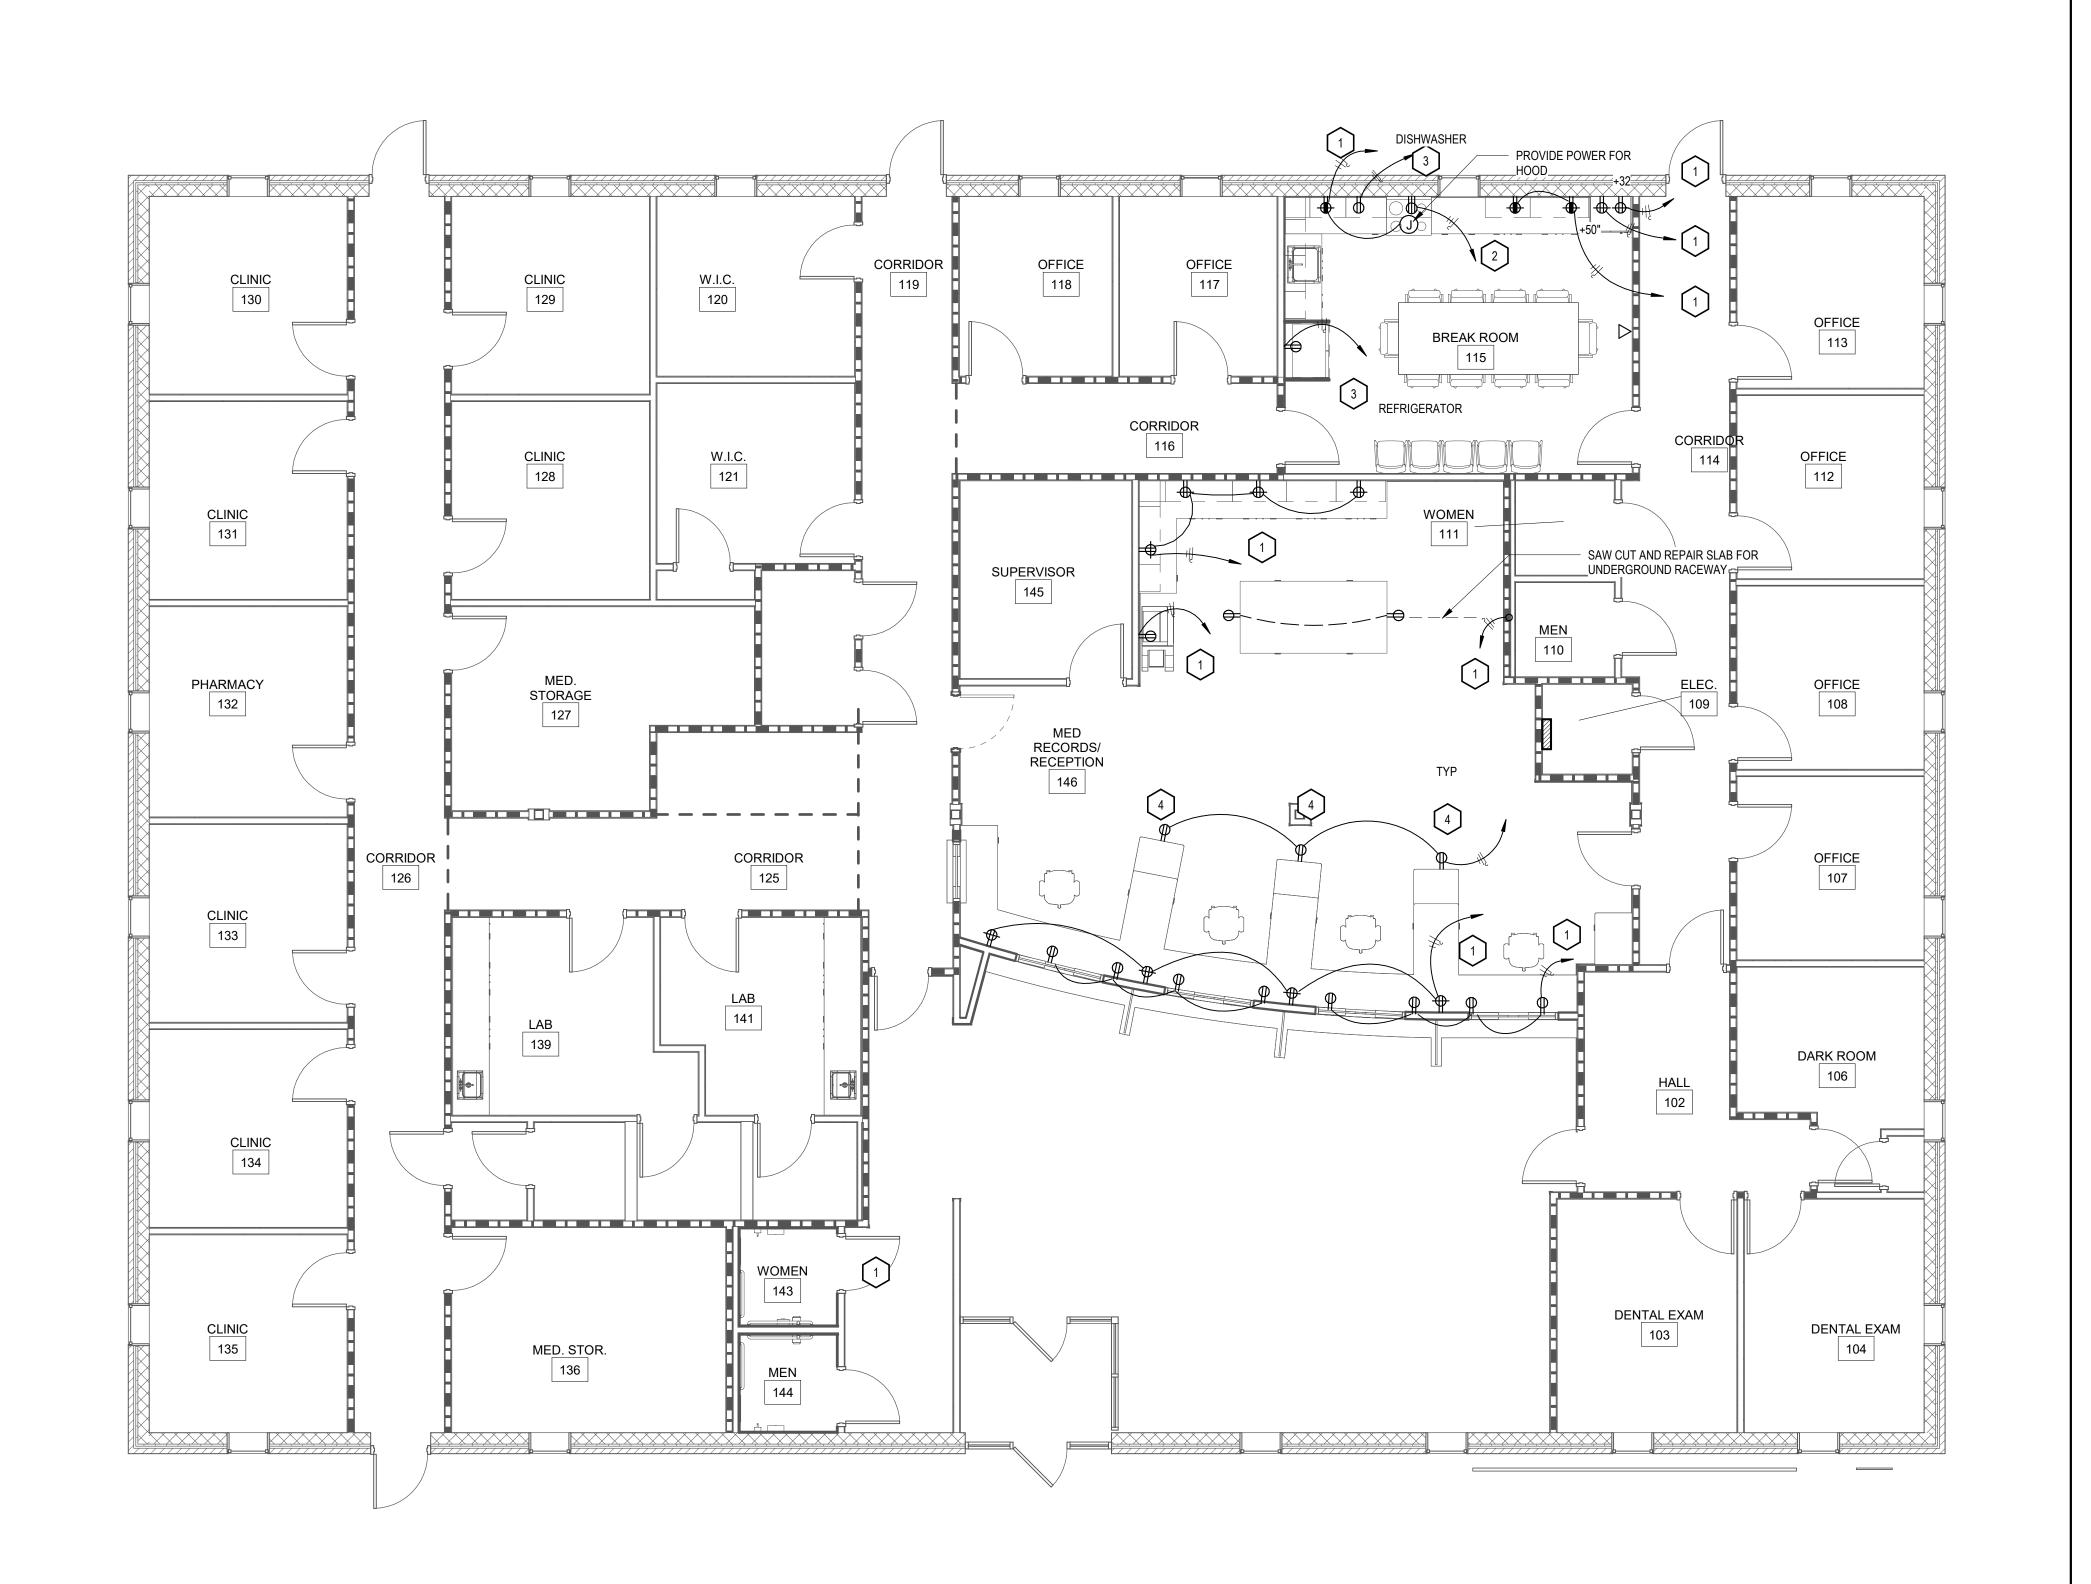

3/16" = 1'-0"

1. SEE SHEET E0.0.

2. PROVIDE COMMUNICATION PATHWAY SYSTEM. SYSTEM TO INCLUDE OUTLET BOXES, CONDUIT STUBS TO ACCESSIBLE CEILINGS AND J-HOOKS.

KEYED NOTES (#)

1 DEMOLISH WIRING DEVICES IN THIS AREA. MAINTAIN CIRCUITRY FOR USE BY NEW DEVICES.

ENGINEERS ARCHITECTS PLANNERS


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A5

N.T.S.

GENERAL AND KEYED NOTES



FAYETTE COUNTY, TN
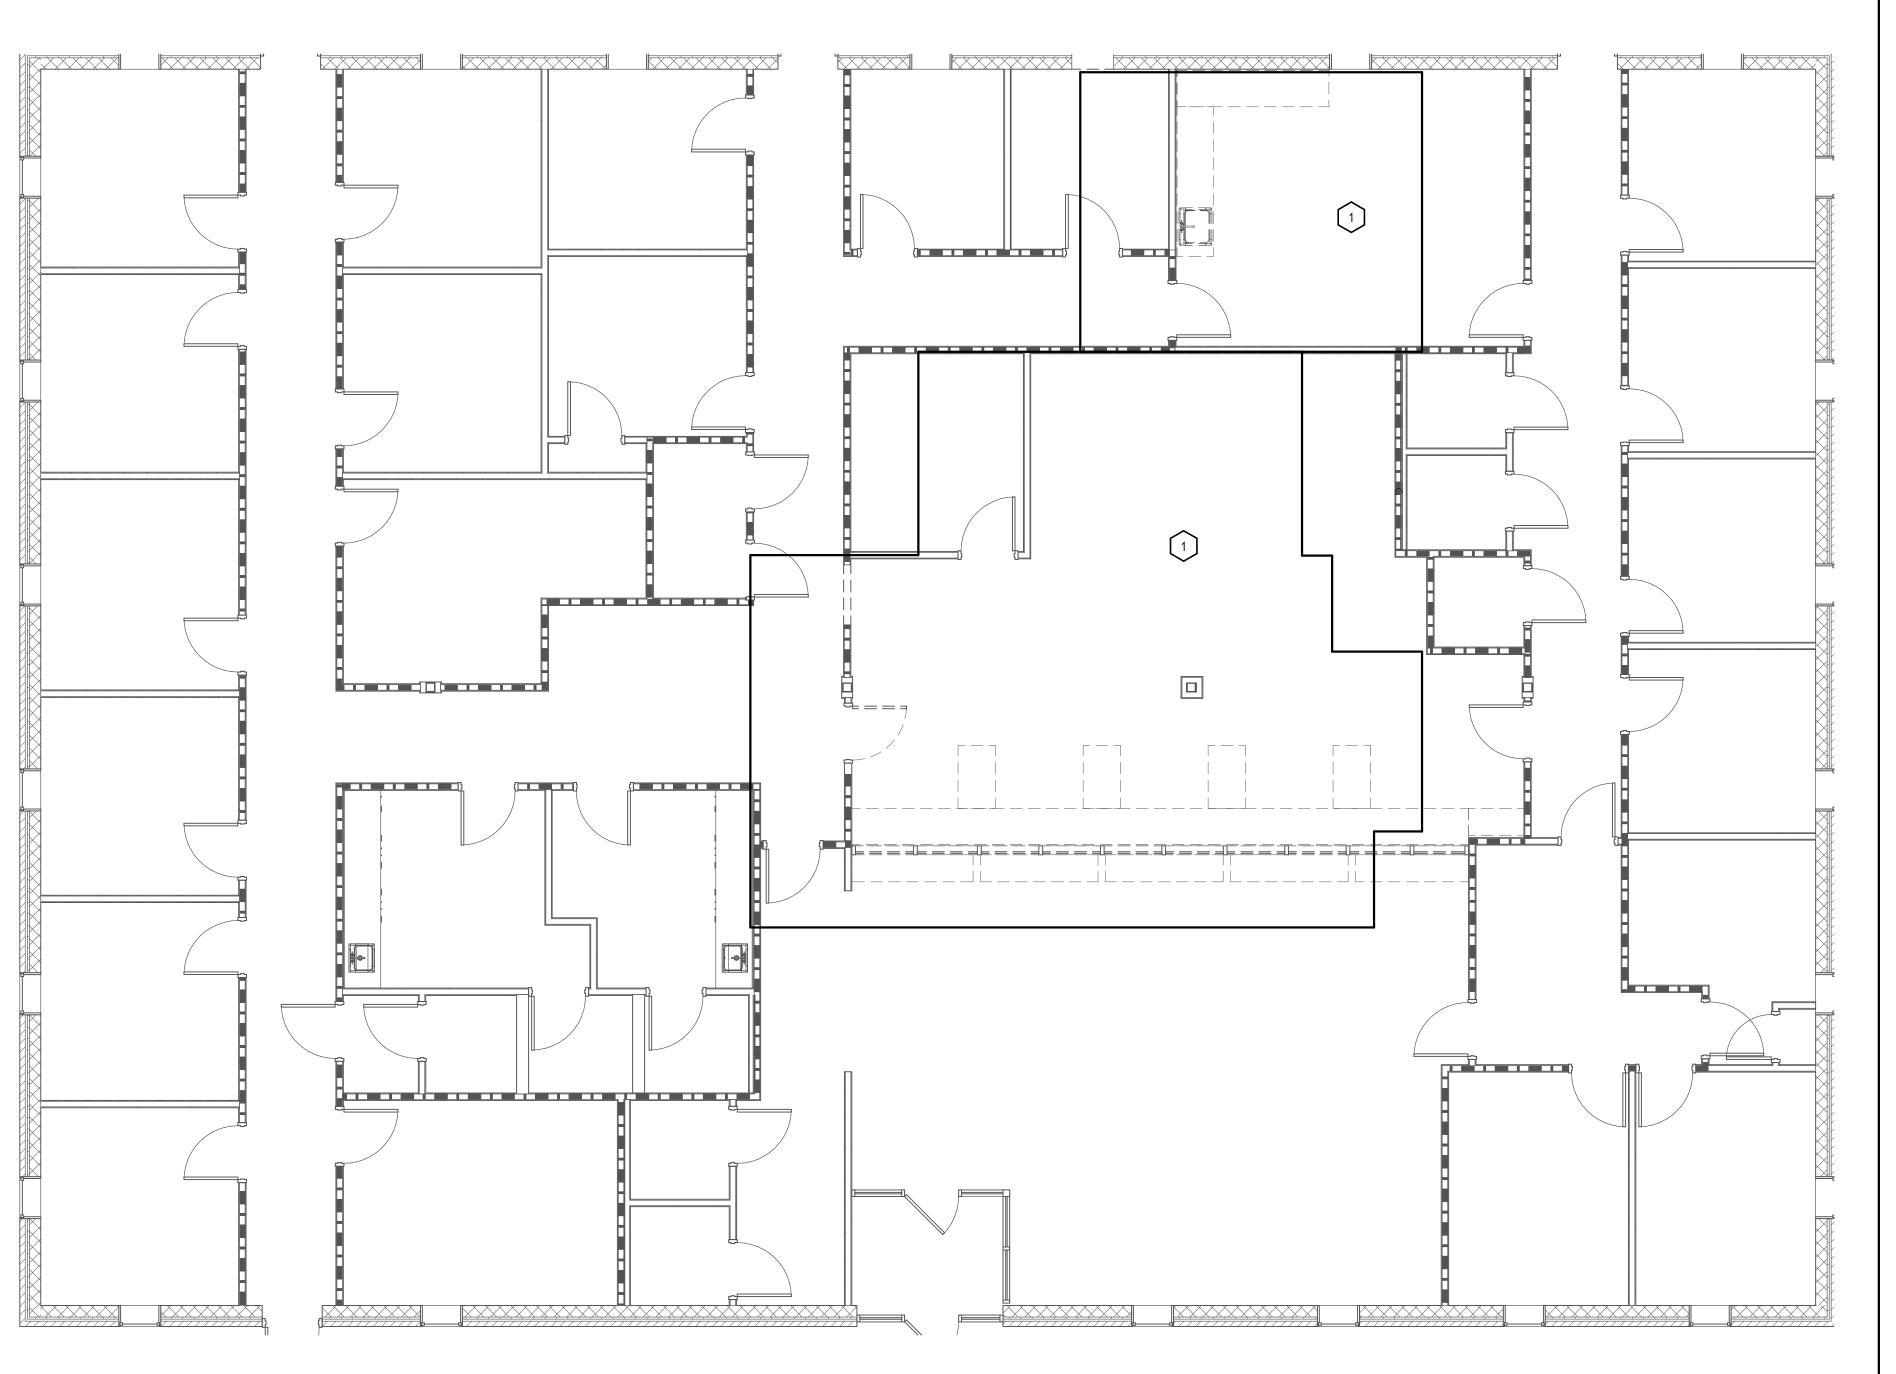
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AUXILIARY - DEMOLITION FLOOR PLAN

1. SEE SHEET E0.0.

2. PROVIDE COMMUNICATION PATHWAY SYSTEM. SYSTEM TO INCLUDE OUTLET BOXES, CONDUIT STUBS TO ACCESSIBLE CEILINGS AND J-HOOKS.



DEMOLISH WIRING DEVICES IN THIS AREA. MAINTAIN CIRCUITRY FOR USE BY NEW DEVICES.




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A5
N.T.S.

GENERAL AND KEYED NOTES



FAYETTE COUNTY, TN
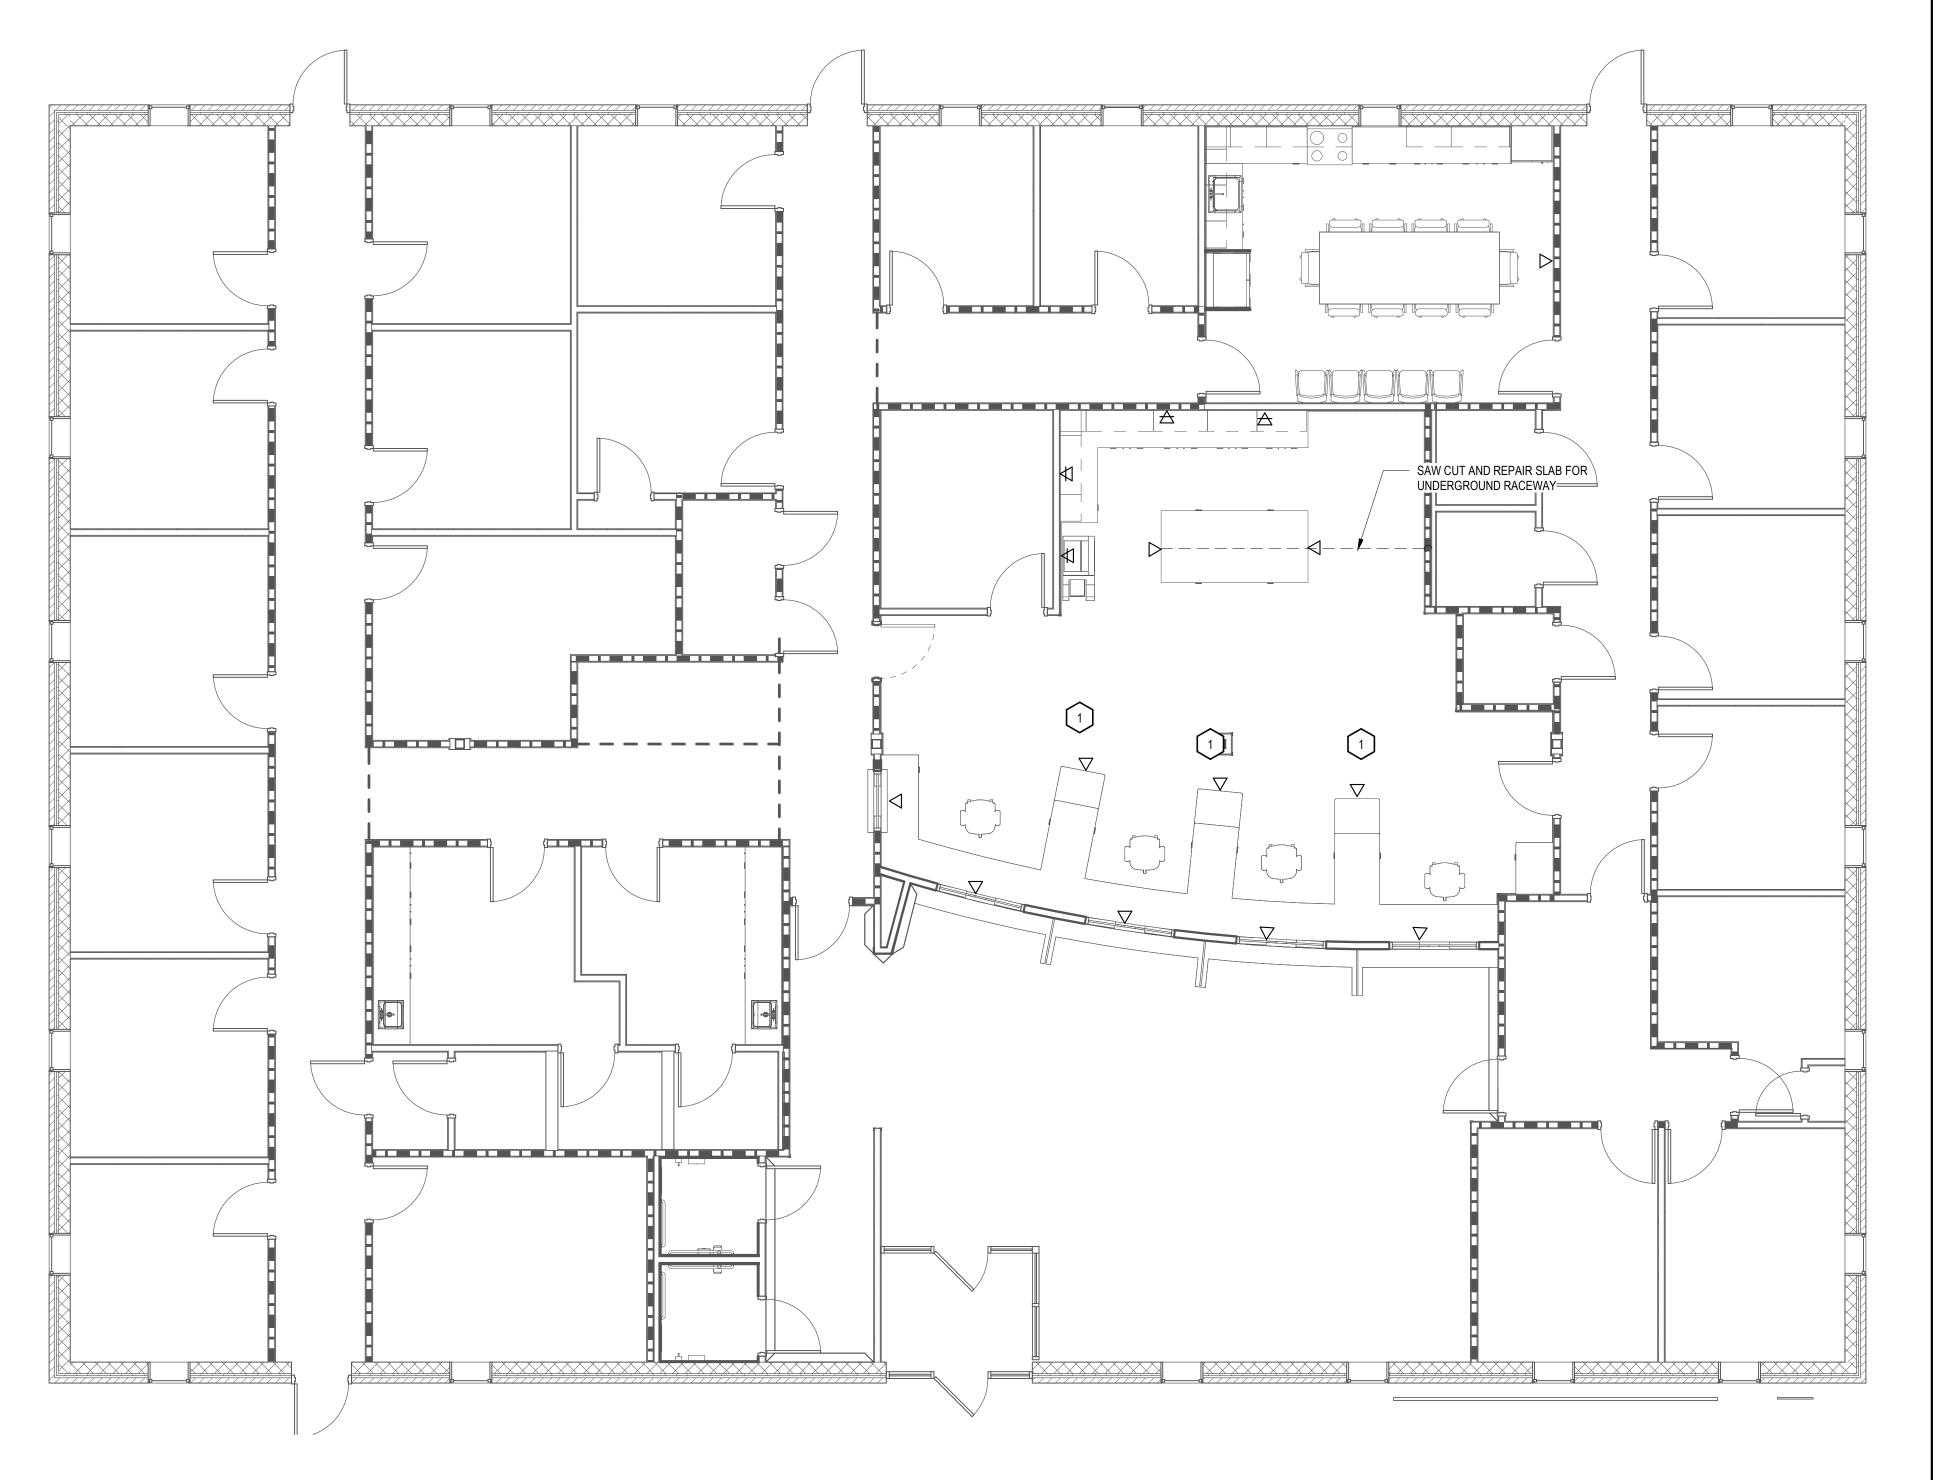
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AUXILIARY - FIRST FLOOR Plan

E3.2

